

Phone: (314) 513-0147 www.crowncastle.com

July 15th, 2022

Barbara Carboni, Town Planner Truro Town Hall 24 Town Hall Road P.O. Box 2030 Truro, MA 02666

RE:

Notice of Application for Site Plan Review for DISH Wireless Telecommunication Colocation Crown Site ID#841273; DISH Site ID# BOSOS00592A 344 Route 6, Truro, MA

Dear Ms. Carboni

Attached is an application for Site Plan Review, for a new wireless collocation on an existing Crown Castle owned lattice tower located at 344 Route 6, Truro.

DISH officially entered the wireless retail space on July 1, 2020. Today, DISH Wireless is the fourth-largest wireless carrier in the United States with 8.9 million subscribers. DISH provides wireless voice and data services in the United States under the Boost Mobile brand and will provide services under its own brand after its network is built. This Application brought forth pertains to DISH's network build.

This collocation of new Transmission Equipment is for a Wireless Communications Facility ("Facility") located at the Site. The installation consists primarily of the following: adding three (3) antennas, six (6) remote radio units, and one (1) over voltage protection device at the 122' centerline height on the tower, three (3) DC power cables, three (3) fiber trunks and one (1) radio cabinet in the existing fenced compound, as depicted in the attached stamped plans.

Please feel free to contact me with any questions, and I look forward to working with you.

Sincerely,

Katie Adams

Katie Adams Crown Castle, Agent for DISH Wireless kadams@nbcllc.com (781) 392-7547



4545 E River Rd, Suite 320 West Henrietta, NY 14586

Phone: (585) 445-5896 Fax: (724) 416-4461 www.crowncastle.com

Crown Castle Letter of Authorization

MA - TOWN OF TRURO Planning Department 24 TOWN HALL ROAD TRURO, MA 02666

Re: Application for Zoning/Building Permit Crown Castle telecommunications site at:

344 ROUTE 6, NORTH TRURO, MA 02652

NCWPCS MPL 24 - YEAR SITES TOWER HOLDINGS LLC ("Crown Castle") hereby authorizes DISH Wireless LLC, including their Agent, to act as our Agent in the processing of all zoning applications, building permits and approvals through the TOWN OF TRURO for the existing wireless communications site described below:

Crown Site ID/Name: 841273/TRURO

Customer Site ID: BOBOS00592A/MA-CCI-T-841273

Site Address: 344 ROUTE 6, NORTH TRURO, MA 02652

Richard Zajac

Crown Castle

Site Acquisition Specialist

Town of Truro Planning Board

P.O. Box 2030, Truro, MA 02666

APPLICATION FOR TELECOMMUNICATION STRUCTURES, BUILDINGS AND APPURTENANCES SITE PLAN REVIEW

To the Town Clerk and the Planning Board of the Tow	n of fruro, MA Date
The undersigned hereby files an application with the T	ruro Planning Board for the following:
Site Plan Review pursuant to §40.	5 of the Truro Zoning Bylaw
1. General Information Description of Property and Proposed Project DISH V 344 Route 6. DISH to install 3 panel antennas and and	Vireless collocation on an existing Lattice Tower located at cillary equipment on the existing tower, with a 5'x7' pad for
equipment cabinet on the ground, within the existing c	
Property Address 344 Route 6, Truro	Map(s) and Parcel(s) 39-172-A
Registry of Deeds title reference: Book and Land Ct. Lot	, Page, or Certificate of Title # and Plan #
Applicant's Name Katie Adams on behalf of Crown Ca	
Applicant's Legal Mailing Address100 Apollo Drive,	Suite 303, Chelmsford MA 01824
Applicant's Phone(s), Fax and Email 781-392-7547 k	
Applicant is one of the following: (please check appropria	required for submittal of this application.
Owner's Name and Address Owner's Name and Address	✓ Other* ver Rd. Suite 320, West Henrietta, NY 14586
Representative's Name and Address Richard Zajac 45	45 E. River Rd. Suite 320, West Henrietta, NY 14586
Representative's Phone(s), Fax and Email <u>585-445-58</u>	96 Richard.Zajac@crowncastle.com
requirements of §40.5, provided that in the opinion of to the public interest, cause the Town any expense, or be	pon the request of the applicant, pursuant to \$70.3.E, waive the Planning Board such a waiver would not be detrimental be inconsistent with the intent and purpose of this Bylaw. A banied by a reasonable explanation as to why the waiver is applicant shall explain why each waiver is requested.
The applicant is <i>advised</i> to consult with the Burnepartment, and/or Health Department prior to substitution.	ilding Commissioner, Planning Department, Conservation omitting this application.
Signature(s)	
Katie Adams Applicant(s)/Representative Printed Name(s) Katie Adams	Owner(s) Printed Name(s) or written permission
Applicant(s)/Representative Signature(s)	Owner(s) Signature(s) or written permission

Your signature on this application authorizes the Members of the Planning Board and town staff to visit and enter upon the subject property.

Telecommunication Structures, Buildings and Appurtenances Site Plan – June 2022

Addre	ddress: 344 Route 6 Applicant Name: Katie Adams c/o Crown Castle Date: 7/15/2022.							
No.	Requirement	Included	Not Included	Explanation, if needed				
B. Reg	<u>uirements</u>							
1	All building permits for a communications structure, building or appurtenance shall require a special permit from the Planning Board.			seeking SP				
2	The minimum distance from the perimeter of the communications structure to any property line shall be the height of the structure including any antennas or appurtenances, plus ten (10) feet. The minimum distance from any guy wire, anchor or brace to any property line shall be the length of the guy wire or brace plus ten (10) feet. The setbacks for a communications building shall comply with the setback requirements of the zoning district.	x						
3	The communications structure, building or appurtenance shall be installed, maintained and operated in accordance with all applicable federal, state, county and local codes, standards and regulations and shall be designed to withstand sustained winds and gusts of a category 5 hurricane. If Federal Aviation Administration (FAA) or Federal Communications Commission (FCC) regulations are changed, then the owner or operator shall bring the structure, building and appurtenances into compliance with the new regulations within six (6) months of the effective date of such regulations or earlier if a more stringent compliance schedule is included in the regulation. Failure to comply with any new regulations shall be grounds for the removal of non-complying structures, buildings and appurtenances at the owner's expense.	X						
4	The height of the communications structure (tower) shall be no greater than one hundred and fifty (150 feet) above ground level.			n/a - tower existing				
5	Communication antennas shall be located on pre-existing structures unless the applicant demonstrates that there are no feasible pre-existing structures. The installation shall preserve the character of such pre-existing structures.	Х						
6	If the applicant has demonstrated that there are no feasible pre-existing structures to support antennas and appurtenances for the intended use, then any communications structure, building or appurtenance may be sited on public land.			n/a				

Addre	Address: 344 Route 6 Applicant Name: Katie Adams c/o Crown Castle Date: 7/15/2022						
No.	Requirement	Included	Not Included	Explanation, if needed			
7	To the extent lawful and feasible, all service providers shall co-locate on a single tower. Towers shall be designed to structurally accommodate the maximum number of foreseeable users (within a ten-year period) technically practicable. The applicant is required to document all co-location tenants and provide a tower design indicating types and location of all facilities.	х					
8	New facilities or structures shall be considered only upon a finding by the Planning Board that existing or approved facilities or structures cannot accommodate the wireless communications equipment planned for the proposed tower.			n/a			
9	The installation of a communications structure, building or appurtenance shall be designed to minimize visual impact; the maximum amount of natural vegetation shall be preserved; details of construction and finish shall blend with the surroundings; additional vegetative screening shall be employed where practical and particularly to screen abutting residential property whether developed or not. A detailed landscape plan will be required with the application.	x					
10	Location and siting of facilities and structures shall be consistent with any regional location and siting criteria established by the Cape Cod Commission.			n/a			
11	Under normal operating conditions, noise emanating from the communications structure, building or appurtenance shall not be greater at the boundary of the lot on which it is sited than would otherwise exist in the absence of these facilities.	х					
12	No hazardous waste shall be discharged on the site. Any storage of fuel shall be in compliance with the Board of Health regulations. Documentation shall be provided for the contents of all communications buildings and/or cabinets.			n/a			
13	All run-off of storm water from communications structures, buildings, and appurtenances, driveways and parking areas shall be contained on site; the amount of impervious surface on the site shall be minimized.	х					
14	Lighting, when required and permitted by the FAA or the Planning Board, shall be directed inward so as not to project onto surrounding properties.			n/a			

Addre	Address: 344 Route 6 Applicant Name: Katie Adams c/o Crown Castle Date: 7/15/2022						
No.	Requirement	Included	Not Included	Explanation, if needed			
15	All structures, buildings or appurtenances must be secured to control access. Fencing materials shall be consistent with the character of abutting properties, with a locked gate and proper warning signals. A sign must be displayed indicating the name of the owner(s) and a 24 hour contact number. Only signs limited to safety will be allowed. Fencing is not required for antennas or other appurtenances mounted on a pre-existing structure.			n/a			
16	As a condition of approval of the application the applicant shall agree, by execution of a covenant, to remove within six months any communications structure and building which has not operated for four consecutive months unless the cause is major damage which prohibits operation. In the event that major damage has rendered the facility inoperative, repair or removal of the facility shall begin within six months and be completed within an additional six months. Failure to comply with the conditions of the covenant shall be grounds for the removal of structures, buildings and appurtenances. Complete restoration of the site shall be at the owner(s) expense, secured by a bond from a recognized financial institution. The covenant shall include, also at the owner(s) expense, provision for liability insurance for any damage to any abutting property whether developed or not.	x					
17	At least forty-five (45) days before submitting an application for a special permit for the installation of a communications structure, building or appurtenance the applicant shall consult with the Planning Board. The purpose of the consultation is to facilitate the permitting process by the exchange of information between the applicant and the Planning Board, and for the applicant to obtain a detailed description of the information and documentation required, in writing, by the Planning Board, in order to clarify and resolve concerns of the Board and minimize potential problems with the application.	х					
18	The Planning Board shall hold a public hearing within sixty-five (65) days of the filing of an application and shall issue a decision within ninety (90) days following the date of the public hearing.						
19	The applicant shall submit the following written information to the Planning Board:						

Addres	Address: 344 Route 6 Applicant Name: Katie Adams c/o Crown Castle Date: 7/15/2022						
No.	Requirement	Included	Not Included	Explanation, if needed			
19.a.	A survey of all sites for the installation of communications structures, buildings or appurtenances which are feasible for providing the intended services. The survey shall include a rationale for the selection of a prime and at least one alternative site. All sites in Truro shall be located on the appropriate sheet(s) of the Truro Assessor's Atlas;			n/a			
19.b.	A survey of all pre-existing structures which are capable of supporting the equipment necessary to provide the intended service and a technical report which demonstrates why any such structure cannot be used by the applicant;			n/a			
19.c.	The radiation pattern of all proposed antennas showing the frequency and intensity of radiation at ground level and at 30 feet above ground level. At the expense of the applicant, Electro Magnetic Field (EMF) readings shall be provided to the Board of Health yearly and immediately after any addition to the facility;	Х					
19.d.	The sound level in decibels at ground level, at 30 feet above ground level and at the top of the facility and 10, 50, 100 and 500 feet from the communications structure, building or appurtenances for wind velocities between calm and 100 miles per hour with all equipment operating at normal levels, including before condition measured, after condition prediction and cumulative condition (with co-location) prediction;			n/a			
19.e.	A delineation of the Assessor's Atlas of all areas in Truro which will not be served by the proposed installation for the prime and an alternative site;			n/a			
19.f.	A statement of the services to be supported by the proposed communications structure, building or appurtenance;	Х					
19.g.	Plans of special design features and materials, including landscaping, to minimize the visual impact of proposed communications structures, buildings and appurtenances. Site plans, elevations and fall zone should be included;			n/a			
19.h.	A certification that the applicant has complied with all federal (including FAA), state and regional requirements to provide the proposed service and demonstration of compliance with the FCC guidelines for EMF's under National Environmental Policy Act (NEPA), including copies of the FCC Form 600, plus Environmental Assessment/Environmental Impact Statements as applicable;	x					

Addres	ddress: 344 Route 6 Applicant Name: Katie Adams c/o Crown Castle Date: 7/15/2022 Date: 1/2022					
No.	Requirement	Included	Not Included	Explanation, if needed		
19.i.	Within thirty (30) days after the application filing, the applicant shall arrange to fly a three-foot-diameter balloon at the primary and an alternate site at the maximum height of the proposed installation. The date and location of the flights shall be advertised at least 14 days, but not more than 21 days before the flights, in a newspaper with a general circulation in Truro. Photos shall be provided from all strategic viewing points, per agreement with the Planning Board prior to flight.			n/a		
20	If a communications structure, building or appurtenance is to be installed on a pre-existing private structure or on land or a structure owned, prior to the effective date of the bylaw, by the Commonwealth of Massachusetts, or on land or a structure owned by the Town of Truro, the applicant shall submit the following written information to the Planning Board:					
20.a.	A draft contract, including requirements for removal of all structures and for complete site restoration in the case of discontinued use, between the applicant and the owner (if different from the applicant).					
20.b.	A description of the proposed facility at the proposed prime and alternate sites including:			n/a		
	i) Height of the facility and its associated equipment and antennas;					
	ii) Access roads and power supplies;					
	iii) Type, size and number of transmitters;					
	iv) A list of all fuels to be used on the site and a detailed description of how each shall be contained.					
20.c.	A site plan (scale not less than 1 inch=40 feet), showing the proposed facility, fall zones, existing and proposed contour elevations, 100-year flood zones, water resources, Zones of Contribution, waterways, wetlands and all associated equipment and structures on the site, including elevations of all equipment and structures with sufficient detail to delineate the external finish of all structures and equipment; and					
20.d.	A landscape plan showing the proposed site before and after development, including topography and screening proposed to protect abutters.					
21	For all applications other than those set forth in § 40.5.B.20 above, the applicant shall submit the following written information to the Planning Board:					

Addres	Address: 344 Route 6 Applicant Name: Katie Adams c/o Crown Castle Date: 7/15/2022				
No.	Requirement	Included	Not Included	Explanation, if needed	
21.a.	A statement of the purpose for which the application is made.	Х			
21.b.	The exact legal name of each person seeking a special permit and the address and telephone number or principal place of business of each such person.	х			
21.c.	The name, title, address and telephone number of the attorney or other person to whom correspondence or communications in regard to the application are to be addressed. Notice, orders, and other papers may be served upon the person so named, and such service shall be deemed to be service upon the applicant;	х			
21.d.	A statement of the need for the proposed facility with as much specific information as is practicable to demonstrate the need, including description of the proposed system and how the proposed facility would eliminate or alleviate any existing deficiency or limitation, including all co-location facilities;			n/a	
21.e.	A statement of the benefits expected from the proposed facility with as much information as is practicable;			n/a	
21.f.	A description of the proposed facility at the proposed prime and alternate sites including:			n/a	
	i) Height of the facility and its associated equipment and antennas;				
	ii) Access roads and power supplies;				
	iii) Special design features and materials, including landscape plans;				
	 iv) Type, size and number of transmitters and receivers, as well as the signal frequency, power output, and power density at the tower base, site boundary, and building where people might be exposed to the maximum power densities from the facility; 				
	 v) A map showing any fixed facilities with which the proposed facility would interact; 				
	vi) The coverage signal strength, and integration of the proposed facility with any adjacent fixed facility, to be accompanied by a network plan showing interfaces with any adjacent service areas;				
	vii) A forecast of when maximum capability would be reached for the proposed facility and for facilities that would be integrated with the proposed facility;				
	viii) Documentation of contents of communications buildings and/or cabinets.				

Addres	s: 344 Route 6 Applicant Name: Katie Adams C	o Crown Cas	tle Dat	ce:
No.	Requirement	Included	Not Included	Explanation, if needed
21.g.	A description of the proposed prime and alternative site, including:			N/a
	i) The most recent U.S.G.S. topographic quadrangle map (scale 1 inch = 2,000 feet) marked to show the site of the facility and any significant changes within a one-mile-radius of the site;			
	ii) A map (scale not less than 1 inch = 200 feet) of the lot or tract on which the facility is proposed to be located, showing the acreage and dimensions of such site, the name and location of adjacent public and private roads or the nearest public road, and the names of abutting owners and portions of their lands abutting the site;			
	iii) A site plan (scale not less than 1 inch = 40 feet), showing the proposed facility, fall zones, existing and proposed contour elevations, 100-year flood zones, water resources, Zones of Contribution, waterways, wetlands and all associated equipment and structures on the site, including elevations of all equipment and structures with sufficient detail to delineate the external finish of all structures and equipment;			
	iv) Where relevant, a terrain profile showing the proposed facility and access road and existing and proposed grades; and			
	v) The most recent aerial photograph (scale not less than 1 inch = 1,000 feet) showing the proposed site, access roads and all abutting properties.			
21.h.	A statement explaining mitigation measures for the proposed facility including:			N/a
	 i) Construction techniques designed specifically to minimize adverse effects on natural areas and sensitive areas; 			
	 ii) Special design features made specifically to avoid or minimize adverse effects on natural areas and sensitive areas; 			
	iii) Establishment of vegetation proposed near residential, recreation, and scenic areas;			
	 iv) Special design features made specifically so that the proposed structures, buildings and appurtenances shall blend with pre-existing structures and buildings; 			
	v) Methods for preservation of vegetation for wildlife habitat and screening;			

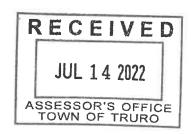
Addres	Applicant Name: Katie Adams c/o Crown Castle Date: 7/15/2022 .					
No.	Requirement	Included	Not Included	Explanation, if needed		
	vi) A list of all fuels to be used on the site and a detailed description of how each shall be contained; and					
	vii) A statement describing any hazardous materials or wastes (including quantities) to be used or generated on the site.					
21.i.	A description of the existing and planned land uses of the proposed prime and alternative sites and surrounding areas;					
21.j.	A description of the scenic, natural, historic, and recreational characteristics of the proposed prime and alternative sites and surrounding areas;					
21.k.	Sight-line graphs to the proposed prime and alternative sites from visually impacted areas (a site from which the facility can be seen) such as residential developments, recreational areas, and historic sites;					
21.1.	A list describing the type and height of all existing and proposed communication structures, buildings and appurtenances within a ten-mile radius within the search area, or within any other area from which use of the proposed prime or alterative structure might be feasible from a location standpoint for purposes of the application;					
21.m.	A description of efforts to share existing and proposed structures, or consolidate telecommunications antennas of public and private services onto the proposed facility;					
21.n.	A description of the technical alternatives and a statement containing justification for the proposed facility;					
21.o.	A description of rejected sites with a U.S.G.S. topographic quadrangle map (scale 1 inch = 2,000 feet) marked to show the location of rejected sites;					
21.p.	A detailed description and justification for the site selected, including a description of siting criteria and the process by which other possible sites were considered and eliminated including but not limited to, environmental effects, cost differential, coverages lost or gained, potential interference with other facilities, and signal loss due to topographical features compared to the proposed prime and alternate sites;					
21.q.	A statement describing hazards to human health, if any, with supporting data and references to regulatory standards;					
21.r.	A statement of the estimated costs for site acquisition and construction of a facility at the prime and alternative sites;					

Address: 344 Route 6 Applicant Name: Katie Adams c/o Crown Castle Date: 7/15/2022.					
No.	Requirement	Included	Not Included	Explanation, if needed	
21.s.	A schedule showing the proposed program of site acquisition, construction, completion, operation and relocation or removal of the existing facilities for the prime and alternative sits;				
21.t.	A copy of any filing or application that the applicant has been required to make together with any decision with regard to such filing or application;				
21.u.	A landscape plan showing the proposed site and location before and after development, including topography screening proposed to protect abutters;				
21.v.	Plans which show location and siting at a prime and at an alternate site; and				
21.w.	A technical report which demonstrates that the maximum height of the installation is the minimum feasible to provide the intended service.				
22	All written information submitted in accordance with the requirements listed in any previous section of this bylaw shall be certified by an appropriate licensed professional.				
23	The Planning Board may also refer applications to the Board of Health, the Zoning Board of Appeals, and the Conservation Commission for review.				
24	The Planning Board shall not approve any application that does not comply with all the requirements of this bylaw. The Board does, however, have the right to waive any part of this bylaw, when in its opinion, such a waiver would not be detrimental to the public interest, cause the Town any expense, or be inconsistent with the intent and purpose of this bylaw.				
25	Any permit issued by the Planning Board for a communications facility shall be valid for the applicant only; it may not be reassigned, leased or sold.				
26	Municipal and private, non-commercial uses are exempted from this bylaw.				
27	The Planning Board shall act in accordance with the standards and requirements set forth herein and in accordance with the Massachusetts General Laws.				
28	The invalidity of any section of this bylaw shall not invalidate any other section.				



TOWN OF TRURO

Assessors Office Certified Abutters List Request Form



DATE: 7/14/2022 NAME OF APPLICANT: DISH Wireless NAME OF AGENT (if any): Katie Adams, on behalf of Crown Castle MAILING ADDRESS: 100 Apollo Drive Suite 303 Chelmsford MA 01824 EMAIL kadams@nbcllc.com HOME/CELL 781-392-7547 CONTACT: PROPERTY LOCATION: 344 Route 6 (street address) PROPERTY IDENTIFICATION NUMBER: MAP ³⁹ ABUTTERS LIST NEEDED FOR: FEE: \$15.00 per checked item (please check all applicable) (Fee must accompany the application unless other arrangements are made) Board of Health⁵ Planning Board (PB) Zoning Board of Appeals (ZBA) X Special Permit¹ **Cape Cod Commission** Special Permit¹ Conservation Commission⁴ Site Plan² Variance¹ Preliminary Subdivision³ Licensing Definitive Subdivision³ Accessory Dwelling Unit (ADU)² Other (Fee: Inquire with Assessors) Note: Per M.G.L., processing may take up to 10 calendar days. Please plan accordingly, THIS SECTION FOR ASSESSORS OFFICE USE ONLY Date request received by Assessors: Date paid: List completed by

¹Abutters, owners of land directly opposite on any public or private street or way, and abutters to the abutters within 300 feet of the property line.

²Abutters to the subject property, abutters to the abutters, and owners of properties across the street from the subject property.

³Landowners immediately bordering the proposed subdivision, landowners immediately bordering the immediate abutters, and landowners located across the streets and ways bordering the proposed subdivision. <u>Note</u>: For Definitive Subdivision only, responsibility of applicant to notify abutters and produce evidence as required.

⁴All abutters within 300 feet of parcel, except Beach Point between Knowles Heights Road and Provincetown border, in which case it is all abutters within 100 feet. Note: Responsibility of applicant to notify abutters and produce evidence as required.

⁵Abutters sharing any boundary or corner in any direction – including land across a street, river or stream. <u>Note</u>: Responsibility of applicant to notify abutters and produce evidence as required.



TRURO ASSESSORS OFFICE

PO Box 2012 Truro, MA 02666

Telephone: (508) 214-0921

Fax: (508) 349-5506

Date: July 14, 2022

To: Katie Adams on behalf of Crown Castle, Agent for DISH Wireless

From: Assessors Department

Certified Abutters List: 344 Route 6 (Map 39, Parcel 172)

Planning Board/Special Permit

Attached is a combined list of abutters for the property located at 344Route 6.

The current owner is Town of Truro.

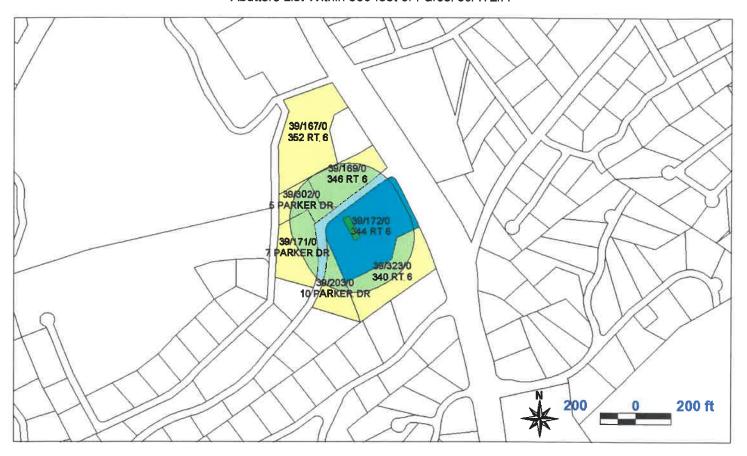
The names and addresses of the abutters are as of July 8, 2022 according to the most recent documents received from the Barnstable County Registry of Deeds.

Certified by:

Olga Farrell Assessing Clerk

TOWN OF TRURO, MA BOARD OF ASSESSORS P.O. BOX 2012, TRURO MA 02666

Abutters List Within 300 feet of Parcel 39/172/A



Key	Parcel ID	Owner	Location	Mailing Street	Mailing City	ST	ZipCd/Country
1291	39-167-0-R	TRI-S PROPERTIES LLC	352 RT 6	PO BOX 1081	TRURO	MA	02666-1081
1293	39-169-0-R	SEAMENS BANK	346 RT 6	PO BOX 74	NO TRURO	MA	02652
1294	39-171-0-R	WESTVIEW COURT REALTY TRUST C/O TRIBUNA JR MICHAEL A	7 PARKER DR	192 MILTON ST	QUINCY	MA	02170
1295	39-172-0-E	TOWN OF TRURO	344 RT 6	PO BOX 2030	TRURO	MA	02666-2030
1296	39-172-A-R	SOUTHWESTERN BELL MOBILE SYSTE D/B/A CINGULAR WRLS-AT&T SVCS	344 RT 6	ATTN: TOWER PROPERTY TAX TEAM 754 PEACHTREE ST, 16TH FLR	ATLANTA	GA	30308
1324	39-203-0-R	COHEN JENNIFER S	10 PARKER DR	110 W 96TH ST #11A	NEW YORK	NY	10025
1421	39-302-0-R	PRIDEAUX-BRUNE DIANA & MAHONEY ANNE	5 PARKER DR	10 MUSEUM WAY, UNIT 1929	CAMBRIDGE	MA	02141
6429	39-323-0-E	TOWN OF TRURO	340 RT 6	PO BOX 2030	TRURO	MA	02666-2030

39-167-0-R

39-169-0-R

39-323-0-E

39-171-0-R

TRI-S PROPERTIES LLC PO BOX 1081 TRURO, MA 02666-1081 SEAMENS BANK PO BOX 74 NO TRURO, MA 02652 WESTVIEW COURT REALTY TRUST C/O TRIBUNA JR MICHAEL A 192 MILTON ST QUINCY, MA 02170

39-172-0-E

39-172-A-R SOUTHWESTERN BELL MOBILE SYSTE D/B/A CINGULAR WRLS-AT&T SVCS ATTN: TOWER PROPERTY TAX TEAM 754 PEACHTREE ST, 16TH FLR

39-203-0-R

TOWN OF TRURO PO BOX 2030 TRURO, MA 02666-2030

ATLANTA, GA 30308

COHEN JENNIFER S 110 W 96TH ST #11A NEW YORK, NY 10025

39-302-0-R

PRIDEAUX-BRUNE DIANA & MAHONEY ANNE
10 MUSEUM WAY, UNIT 1929
CAMBRIDGE, MA 02141

TOWN OF TRURO PO BOX 2030 TRURO, MA 02666-2030 Date: 7/17/2021



Crown Castle 2000 Corporate Drive Canonsburg, PA 15317 (724) 416-2000

Subject: Structural Evaluation

Carrier Designation: DISH Network Co-Locate

Site Number: BOBOS00592A Site Name: MA-CCI-T-841273

Crown Castle Designation: BU Number: 841273

Site Name: TRURO
JDE Job Number: 644620
WO Number: 1968406
Order Number: 552716 Rev. 0

Site Data: 344 Route 6, North Truro, Barnstable County, MA

Latitude: 42° 1' 18" Longitude: -70° 4' 30"

170 Foot - Self Support Tower

Crown Castle is pleased to submit this "**Structural Evaluation**" to determine the structural integrity of the above-mentioned tower. The purpose of this evaluation is to determine the suitability of the tower structure to support the proposed equipment configuration listed in Table 1.

Based on a comparison of loading listed in the previous analysis dated 3/27/2019, the proposed loading change will not have a significant impact on the overall tower stress rating. Therefore, the final proposed equipment configuration listed in Table 1 is structurally **ACCEPTABLE**.

Table 1: Proposed Equipment Configuration

Mounting Level (ft)	Center Line Elevation (ft)	Number of Antennas	Antenna Manufacturer	Antenna Model	Number of Feed Lines	Feed Line Size (in)
		1	RAYCAP	RDIDC-9181-PF-48		
		3	FUJITSU	TA08025-B604		
122	122	3	FUJITSU	TA08025-B605	1	1-1/2
		3	JMA WIRELESS	MX08FRO665-21		
		3	MOUNTS	Commscope MTC3975083		

Respectfully submitted by:

Bradley E. Byrom, P.E., S.E. Senior Project Engineer



Digitally signed by Bradley E Byrom

Date: 2021.07.17 10:29:52 -04'00'



Nationwide Programmatic Agreement Co-location Criteria Verification Form

Site Name: TRURO

YES □

NO \square

Business Unit Number: 841273 App ID: 552716

Site Address: 344 ROUTE 6 NORTH TRURO, MA 02652

Carrier Name: DISH Wireless L.L.C. Customer Site ID: BOBOS00592A

Tower was built on or before 3/16/01? YES ☑ NO □

Criteria for Programmatic Agreement Eligibility for Towers Built on or before March 16, 2001

YES □	NO 🗹	The mounting of the antenna will result in a substantial increase in the size of the tower ¹ .
YES □	NO ☑	The tower has been found by the FCC to have an adverse or potentially adverse effect that has not been resolved through an MOA or other mechanism.
YES □	NO ☑	The tower is the subject of a pending environmental review or proceeding before the FCC involving compliance with Section 106 of the NHPA.
YES □	NO ☑	The tower owner has received written or electronic notice from the FCC that the FCC is in receipt of a complaint from a member of the public, a SHPO or the Council that the co-location has an adverse effect on one or more historic properties.
Criteria for	Programmatic A	Agreement Eligibility for Towers Built after March 16, 2001
YES □	NO □	No Section 106 review (SHPO review) or any associated environmental (NEPA) review required by the FCC has been completed for this tower.
YES □	NO □	The mounting of the antenna will result in a substantial increase in the size of the tower. ¹
YES □	NO □	The tower is the subject of a pending environmental review or proceeding before the FCC involving compliance with Section 106 of the NHPA.

If any of the above answers are "YES," consultation with the SHPO is required prior to placement of the antenna on the tower.

on one or more historic properties.

The tower owner has received written or electronic notice from the FCC that the FCC is in receipt of a complaint from a member of the public, a SHPO or the Council that the co-location has an adverse effect

Approved By: *Christopher Page* 11/11/2021

A COPY OF THIS COMPLETED FORM MUST BE PROVIDED TO THE CARRIER AND TO THE CROWN CASTLE REGULATORY DEPARTMENT.

¹ Substantial increase in size of the tower" means: 1) an increase in the tower height of more than 10% or by the height of one antenna array with a separation distance from the nearest existing array not to exceed 20 feet, whichever is greater; 2) the installation of more than 4 new equipment cabinets or more than 1 new equipment building; 3) the addition of an appurtenance that would protrude from the edge of the tower more than 20 feet or more than the width of the tower at the level of the appurtenance, whichever is greater; or 4) the mounting of the antenna would involve excavation more than 30' in any direction outside the current boundaries of the site and any access or utility easements currently related to the site.

wireless...

DISH Wireless L.L.C. SITE ID:

BOBOS00592A

DISH Wireless L.L.C. SITE ADDRESS:

344 ROUTE 6 NORTH TRURO, MA 02652

MASSACHUSETTS CODE OF COMPLIANCE

ALL WORK SHALL BE PERFORMED AND MATERIALS INSTALLED IN ACCORDANCE WITH THE CURRENT EDITIONS OF THE FOLLOWING CODES AS ADOPTED BY THE LOCAL GOVERNING AUTHORITIES. NOTHING IN THESE PLANS IS TO BE CONSTRUED TO PERMIT WORK NOT CONFORMING TO THESE CODES

CODE TYPE

MA STATE BUILDING CODE, 9TH EDITION (780 CMR)/2015 IBC W/ AMENDMENTS MECHANICAL MA STATE BUILDING CODE, 9TH EDITION (780 CMR)/2015 IMC W/ AMENDMENTS

MA ELECTRICAL CODE/2020 NEC W/ AMENDMENTS

SHEET INDEX					
SHEET NO.	SHEET TITLE				
T-1	TITLE SHEET				
A-1	OVERALL AND ENLARGED SITE PLANS				
A-2	ELEVATION, ANTENNA LAYOUT AND SCHEDULE				
A-3	EQUIPMENT PLATFORM AND H-FRAME DETAILS				
A-4	EQUIPMENT DETAILS				
A-5	EQUIPMENT DETAILS				
A-6	EQUIPMENT DETAILS				
E-1	ELECTRICAL/FIBER ROUTE PLAN AND NOTES				
E-2	ELECTRICAL DETAILS				
E-3	ELECTRICAL ONE-LINE, FAULT CALCS & PANEL SCHEDULE				
G-1	GROUNDING PLANS AND NOTES				
G-2	GROUNDING DETAILS				
G-3	GROUNDING DETAILS				
RF-1	RF CABLE COLOR CODE				
GN-1	LEGEND AND ABBREVIATIONS				
GN-2	GENERAL NOTES				
GN-3	GENERAL NOTES				
GN-4	GENERAL NOTES				

SCOPE OF WORK

THIS IS NOT AN ALL INCLUSIVE LIST. CONTRACTOR SHALL UTILIZE SPECIFIED EQUIPMENT PART OR ENGINEER APPROVED EQUIVALENT. CONTRACTOR SHALL VERIFY ALL NEEDED EQUIPMENT TO PROVIDE A FUNCTIONAL SITE. THE PROJECT GENERALLY CONSISTS OF THE FOLLOWING:

TOWER SCOPE OF WORK:

- INSTALL (3) PROPOSED PANEL ANTENNAS (1 PER SECTOR)
- INSTALL (3) PROPOSED SECTOR FRAMES INSTALL PROPOSED JUMPERS
- INSTALL (6) PROPOSED RRUS (2 PER SECTOR)
- INSTALL (1) PROPOSED OVER VOLTAGE PROTECTION DEVICE (OVP)
- INSTALL (1) PROPOSED HYBRID CABLE

GROUND SCOPE OF WORK:

- INSTALL (1) PROPOSED METAL PLATFORM
- INSTALL (1) PROPOSED ICE BRIDGE
- INSTALL (1) PROPOSED PPC CABINET
- INSTALL (1) PROPOSED EQUIPMENT CABINET
- INSTALL (1) PROPOSED POWER CONDUIT
- INSTALL (1) PROPOSED TELCO CONDUIT
- INSTALL (1) PROPOSED TELCO-FIBER BOX
- INSTALL (1) PROPOSED GPS UNIT
- INSTALL (1) PROPOSED SAFETY SWITCH (IF REQUIRED)
- INSTALL (1) PROPOSED FIBER NID (IF REQUIRED)
- INSTALL (1) PROPOSED NEW 200A METER IN EXISTING SOCKET

SITE PHOTO





UNDERGROUND SERVICE ALERT - 811 DIG SAFE UTILITY NOTIFICATION CENTER OF MASSACHUSETTS (888) 344-7233 WWW.DIGSAFE.COM

CALL 3 WORKING DAYS UTILITY NOTIFICATION PRIOR TO CONSTRUCTION

GENERAL NOTES

THE FACILITY IS UNMANNED AND NOT FOR HUMAN HABITATION. A TECHNICIAN WILL VISIT THE SITE AS REQUIRED FOR ROUTINE MAINTENANCE. THE PROJECT WILL NOT RESULT IN ANY SIGNIFICANT DISTURBANCE OR EFFECT ON DRAINAGE. NO SANITARY SEWER SERVICE, POTABLE WATER, OR TRASH DISPOSAL IS REQUIRED AND NO COMMERCIAL SIGNAGE IS PROPOSED.

11"x17" PLOT WILL BE HALF SCALE UNLESS OTHERWISE NOTED

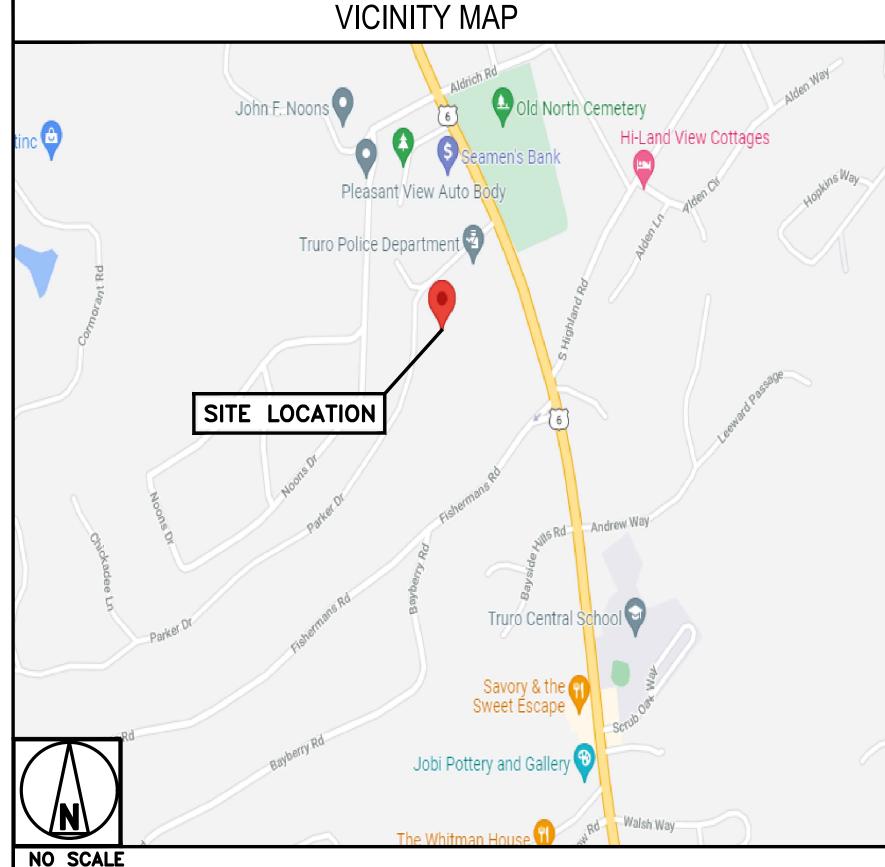
CONTRACTOR SHALL VERIFY ALL PLANS, EXISTING DIMENSIONS, AND CONDITIONS ON THE JOB SITE, AND SHALL IMMEDIATELY NOTIFY THE ENGINEER IN WRITING OF ANY DISCREPANCIES BEFORE PROCEEDING WITH THE WORK.

SITE INFORMATION PROJECT DIRECTORY DISH Wireless L.L.C. TOWN OF TRURO, MA **APPLICANT:** 5701 SOUTH SANTA FE DRIVE LITTLETON, CO 80120 24 TOWN HALL ROAD PROPERTY OWNER: ADDRESS: TRURO, MA 02666 TOWER OWNER: CROWN CASTLE **TOWER TYPE:** SELF SUPPORT 2000 CORPORATE DRIVE CANONSBURG, PA 15317 TOWER CO SITE ID: 841273 TOWER APP NUMBER: 552716 (877) 486-9377 COUNTY: **BARNSTABLE** SITE DESIGNER: HUDSON DESIGN GROUP, LLC. 45 BEECHWOOD DRIVE NORTH ANDOVER, MA 01845 LATITUDE (NAD 83): 42° 1′ 18.00" N 42.02166667 (978) 557-5553 LONGITUDE (NAD 83): 70° 4' 30.00 W -70.07500000 ZONING JURISDICTION: TOWN OF TRURO, MA SITE ACQUISITION: COURTNEY PRESTON courtney.preston.contractor Ocrowncastle.com ZONING DISTRICT: R (RESIDENTIAL) CONSTRUCTION TIMOTHY HARDY 039-000-172-00 PARCEL NUMBER: **MANAGER:** timothy.hardy@dish.com OCCUPANCY GROUP: U RF ENGINEER: NAGESH NAYAK nagesh.nayak@dish.com CONSTRUCTION TYPE: II-B POWER COMPANY: **EVERSOURCE** TELEPHONE COMPANY: CROWN CASTLE

DIRECTIONS

DIRECTIONS FROM BOSTON LOGAN INTERNATIONAL AIRPORT:

START OUT GOING EAST ON RACE POINT RD. TURN RIGHT TO STAY ON RACE POINT RD. TURN LEFT ONTO ROUTE 6/US-6 W. CONTINUE TO FOLLOW US-6 W. 344 ROUTE 6, NORTH TRURO, MA 02652, 344 ROUTE 6 IS ON THE RIGHT.






5701 SOUTH SANTA FE DRIVE LITTLETON, CO 80120



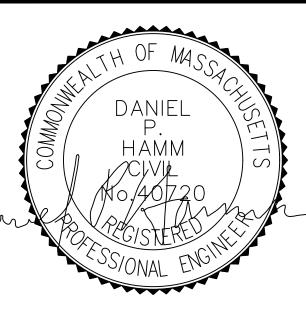45 BEECHWOOD DRIVE N. ANDOVER, MA 01845



IT IS A VIOLATION OF LAW FOR ANY PERSON. UNLESS THEY ARE ACTING UNDER THE DIRECTION OF A LICENSED PROFESSIONAL ENGINEER, TO ALTER THIS DOCUMENT.

DRAWN BY: CHECKED BY: APPROVED BY

RFDS REV #:

PRELIMINARY **DOCUMENTS**

SUBMITTALS DATE DESCRIPTION A 11/15/2021 ISSUED FOR REVIEW B 01/21/2022 ISSUED FOR REVIEW A&E PROJECT NUMBER BOBOSO0592A

DISH Wireless L.L.C. PROJECT INFORMATION


BOBOS00592A

CROWN CASTLE BU#841273 **344 ROUTE 6** NORTH TRURO, MA 02652

> SHEET TITLE TITLE SHEET


SHEET NUMBER

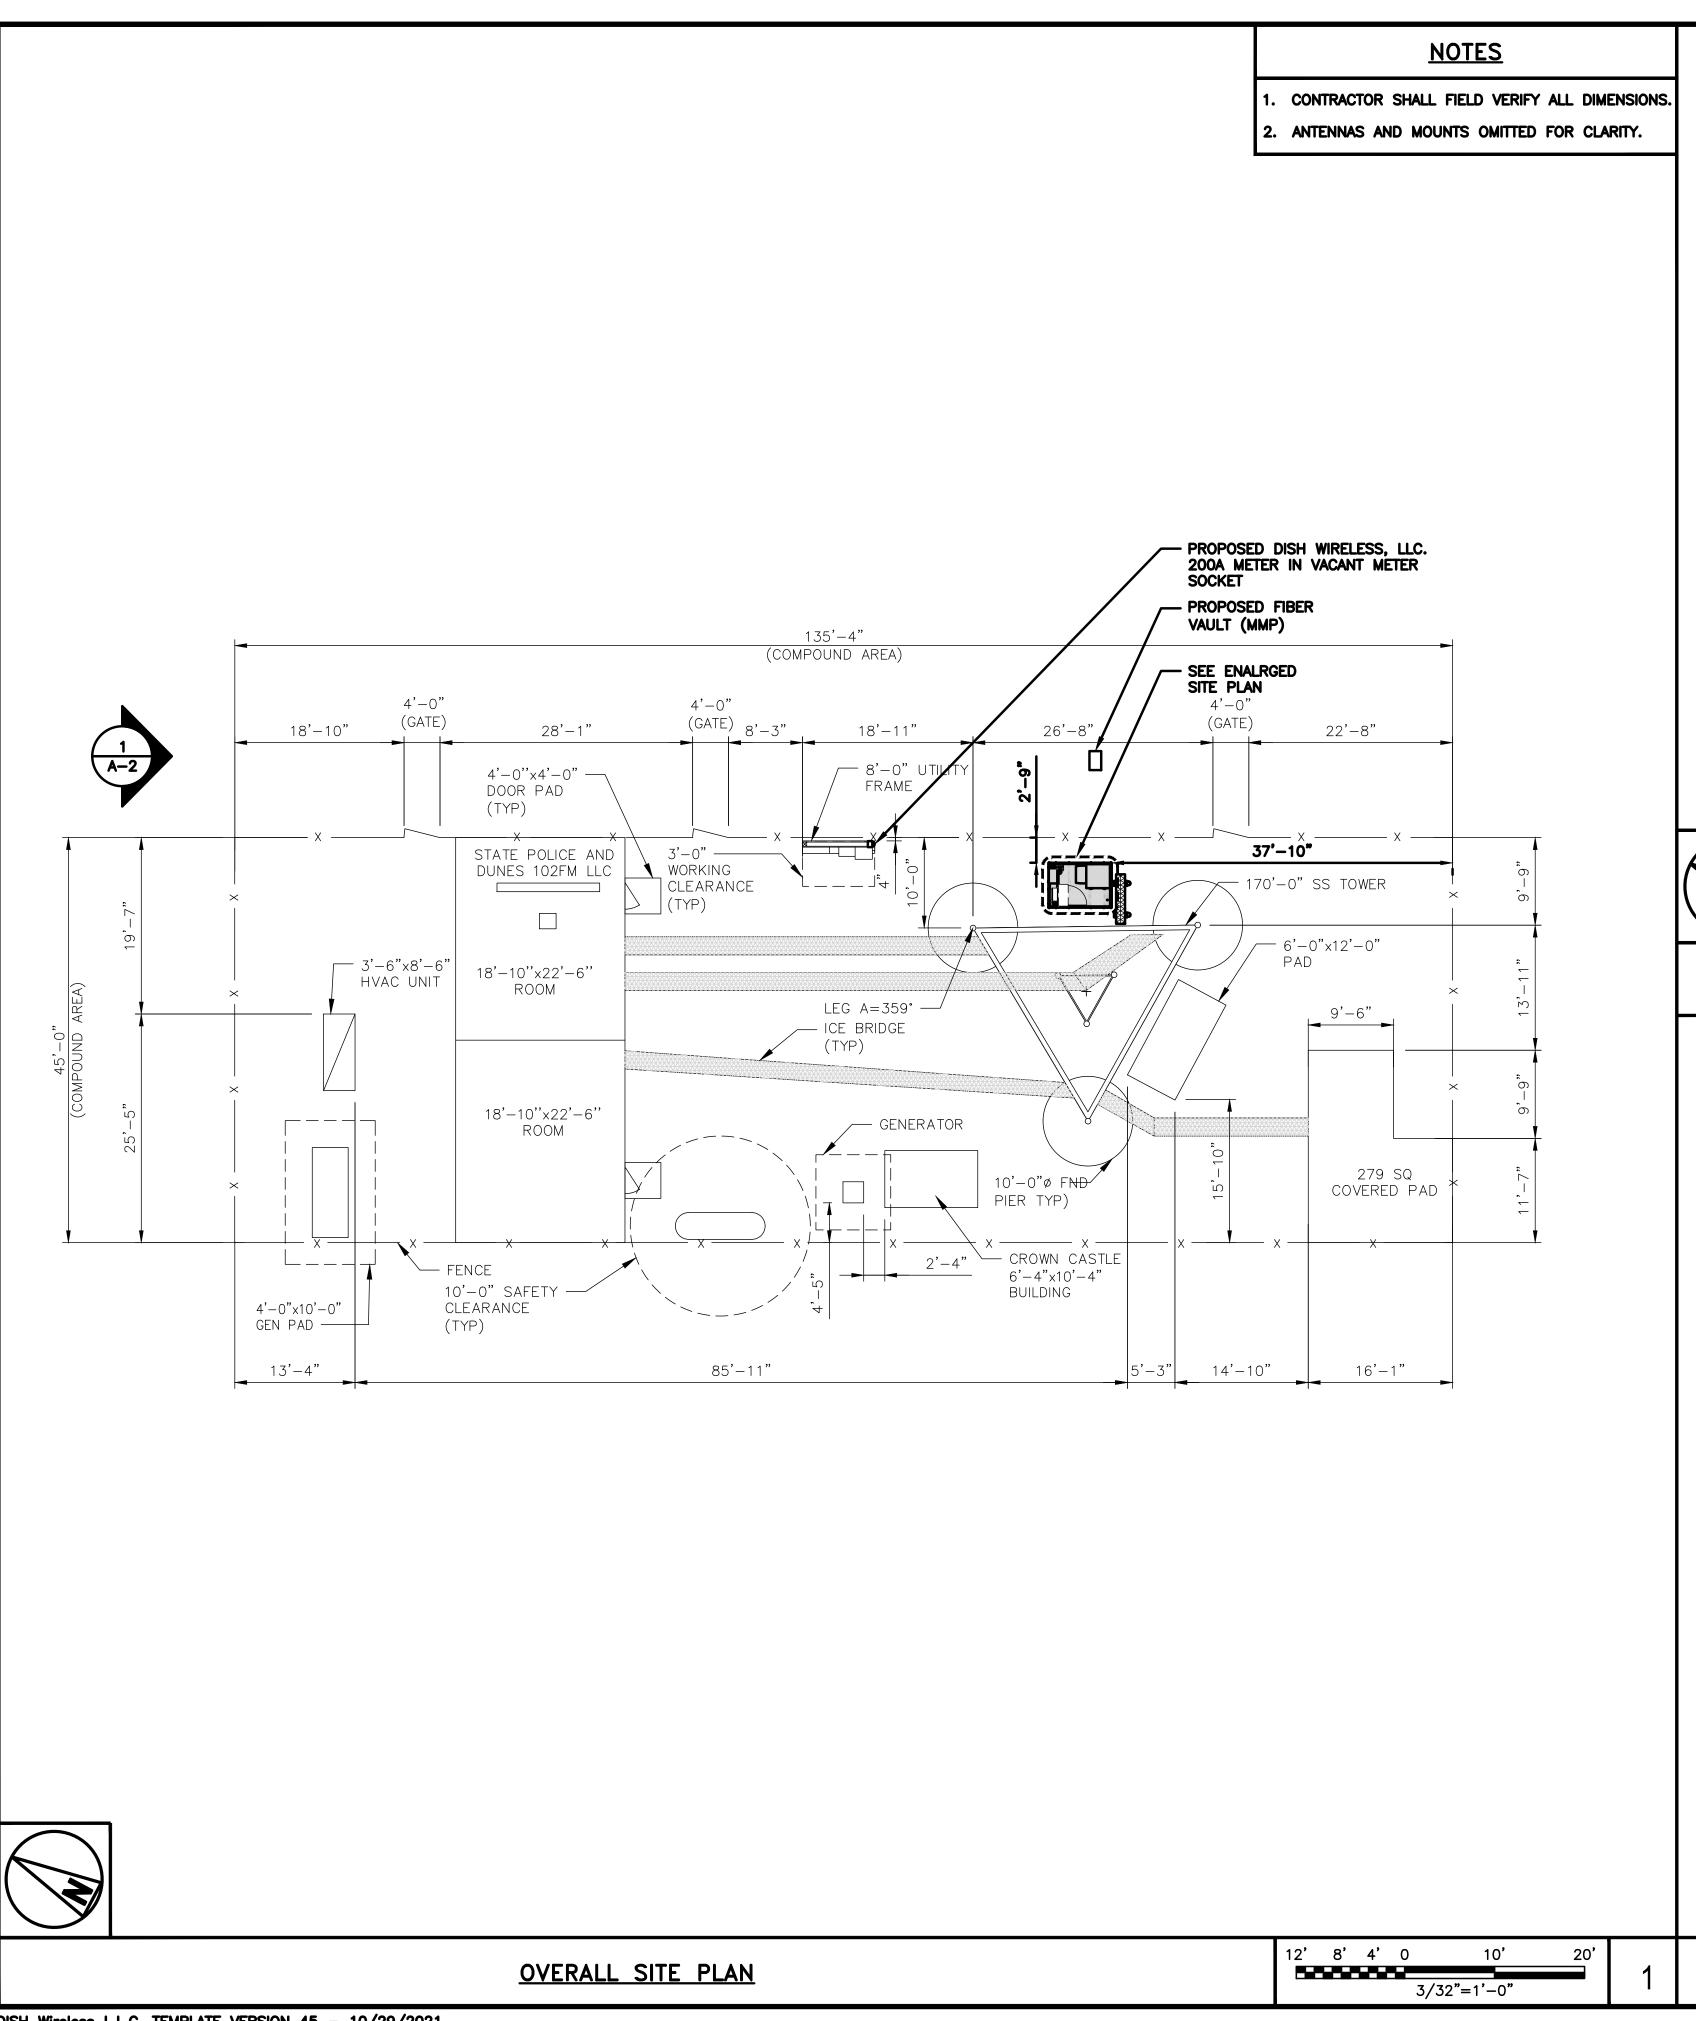T-1





NOTES

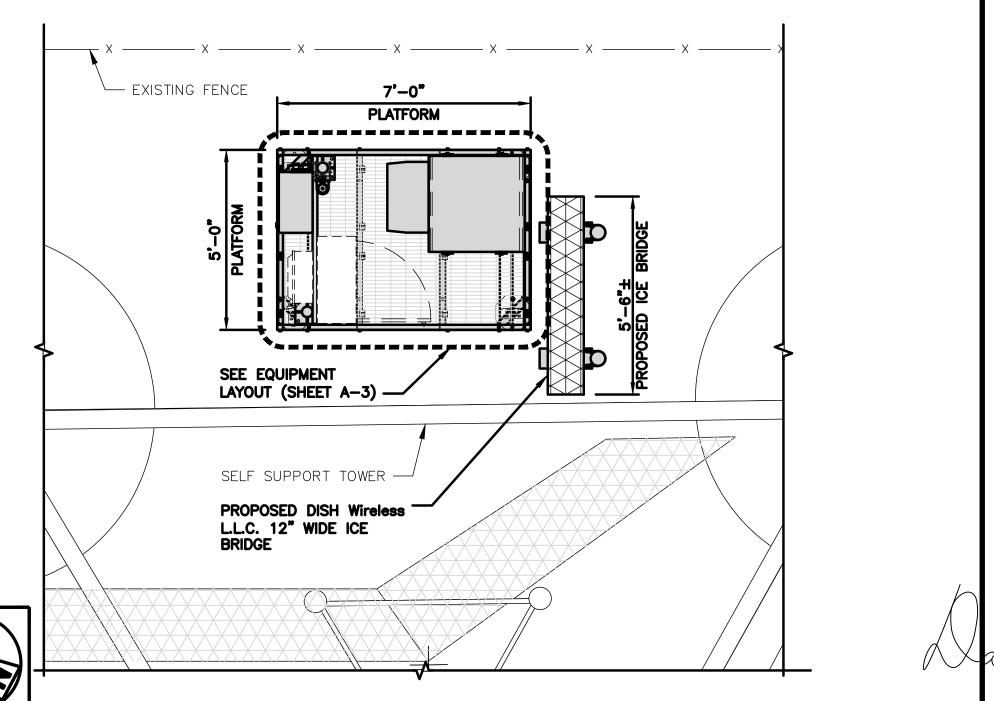- CONTRACTOR SHALL FIELD VERIFY ALL DIMENSIONS.
- 2. CONTRACTOR SHALL MAINTAIN A 10'-0" MINIMUM SEPARATION BETWEEN THE PROPOSED GPS UNIT, TRANSMITTING ANTENNAS AND EXISTING GPS UNITS.
- 3. ANTENNAS AND MOUNTS OMITTED FOR CLARITY.



ENLARGED SITE PLAN

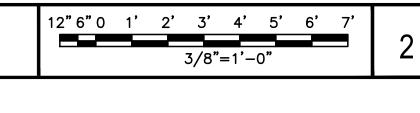

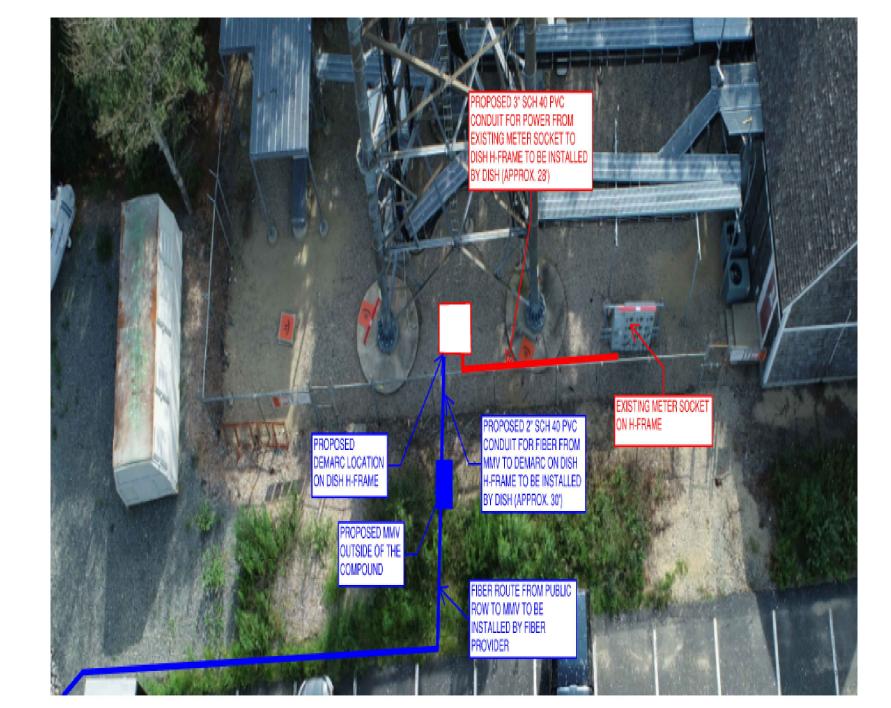


wireless.

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45 BEECHWOOD DRIVE TEL: (978) 557-5553 N. ANDOVER, MA 01845 FAX: (978) 336-5586



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	DRAWN	BY:	CHECKED	BY:	APPROVED	В
	PS		SMA	DPH		
	DEDS I)[\/ .	ш.			
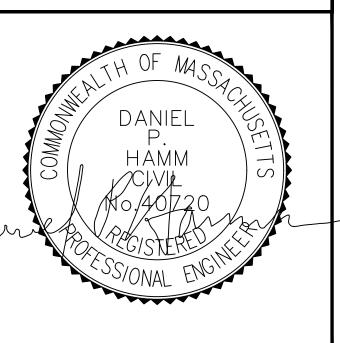
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BOBOSO0592A

DISH Wireless L.L.C. PROJECT INFORMATION BOBOS00592A CROWN CASTLE BU#841273 344 ROUTE 6

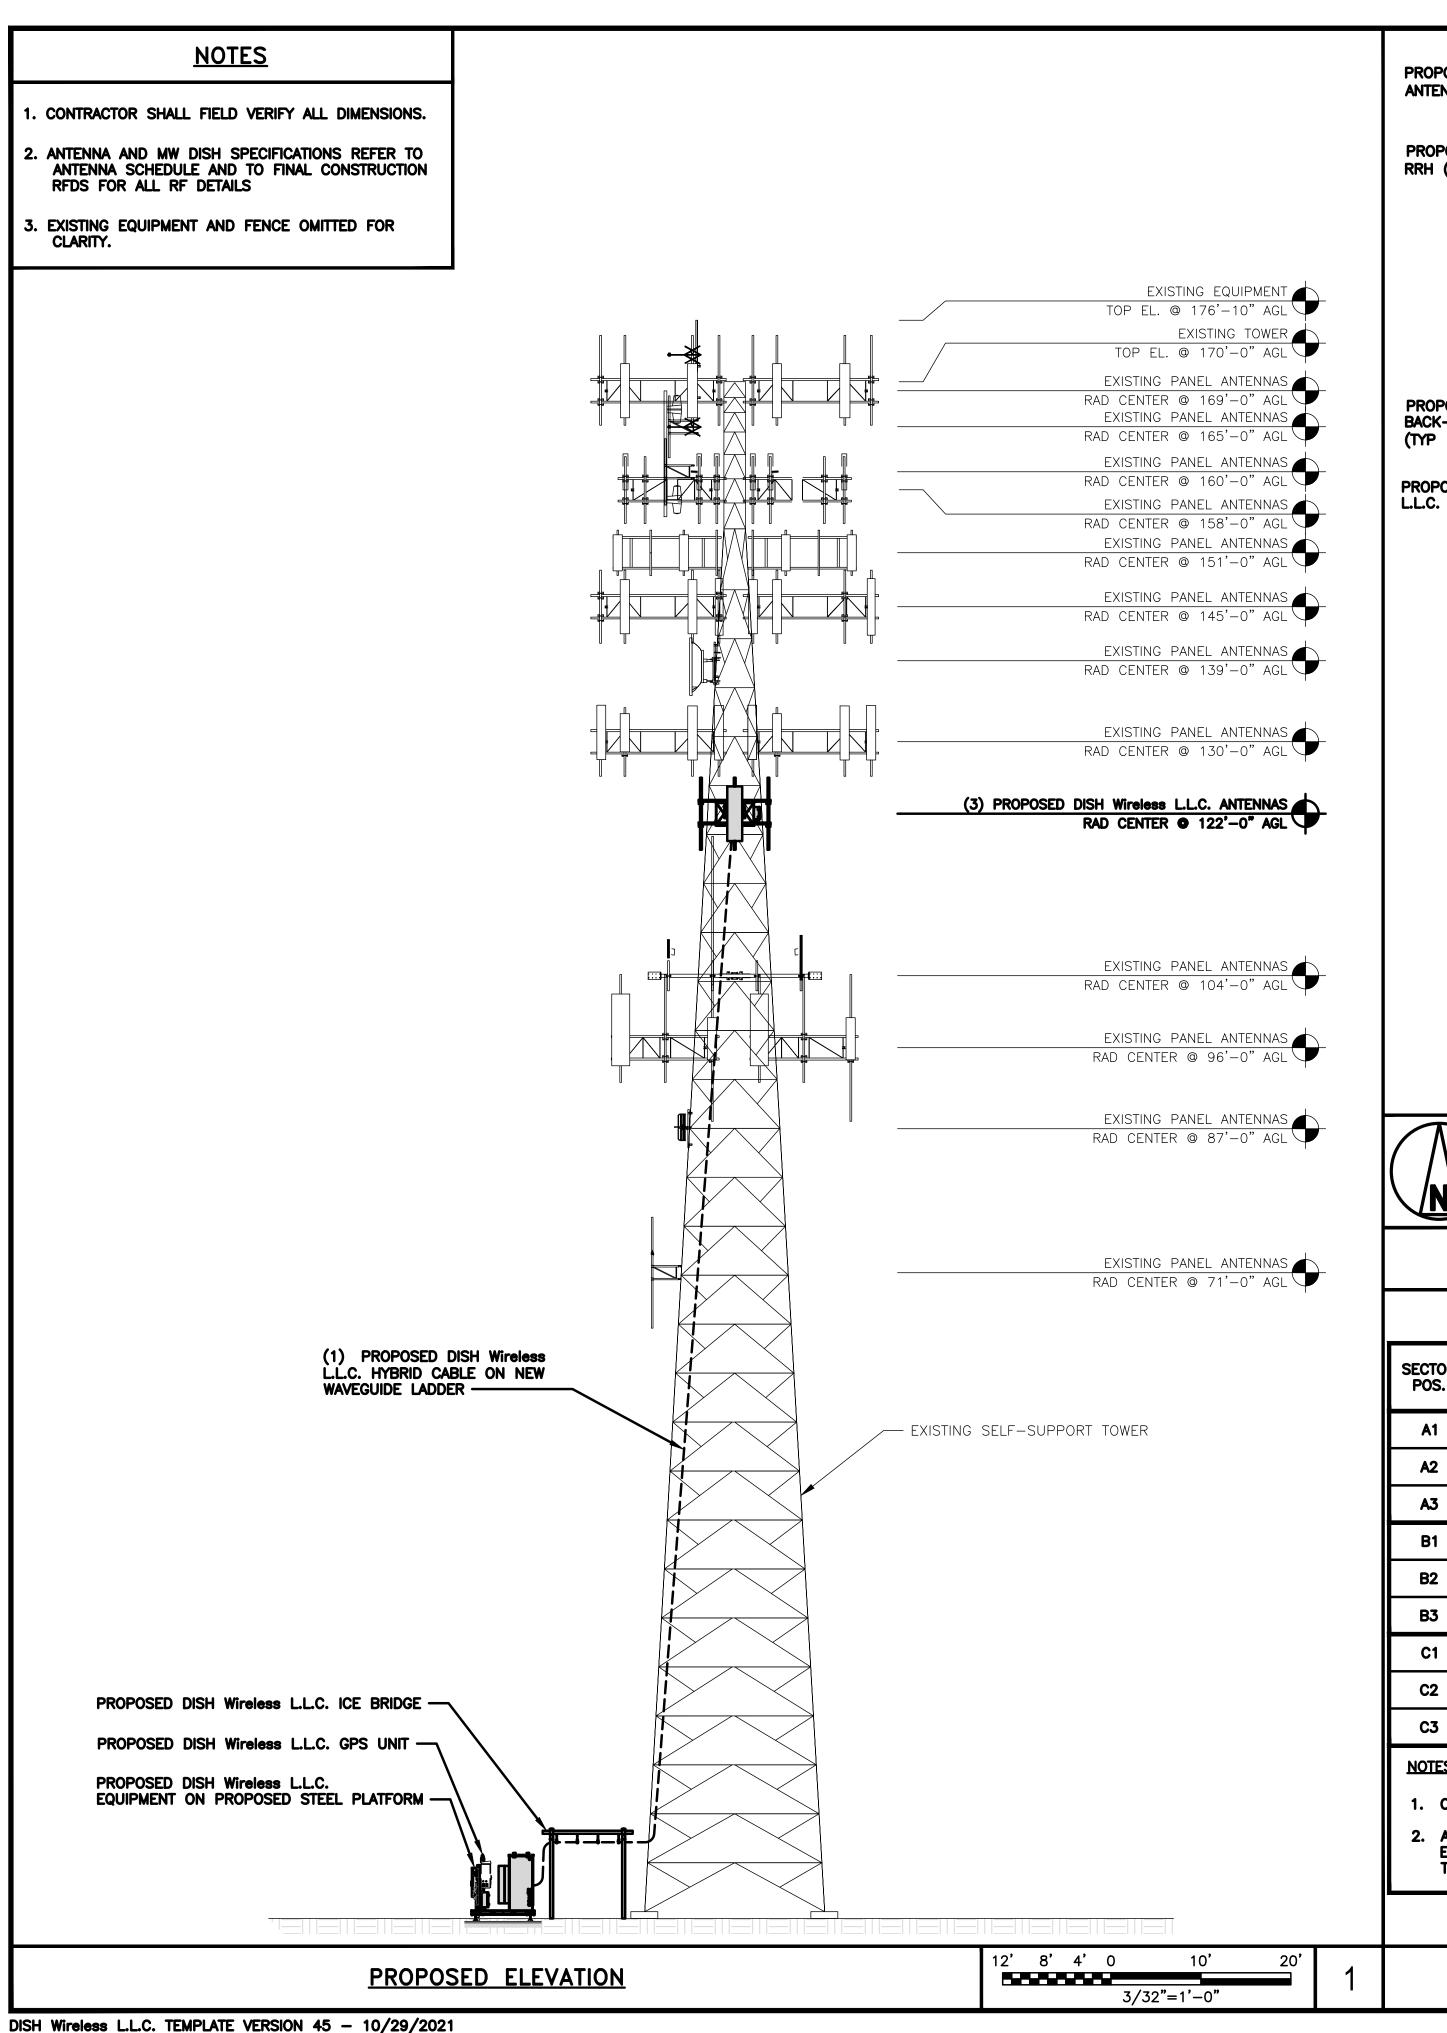
NORTH TRURO, MA 02652 SHEET TITLE OVERALL AND

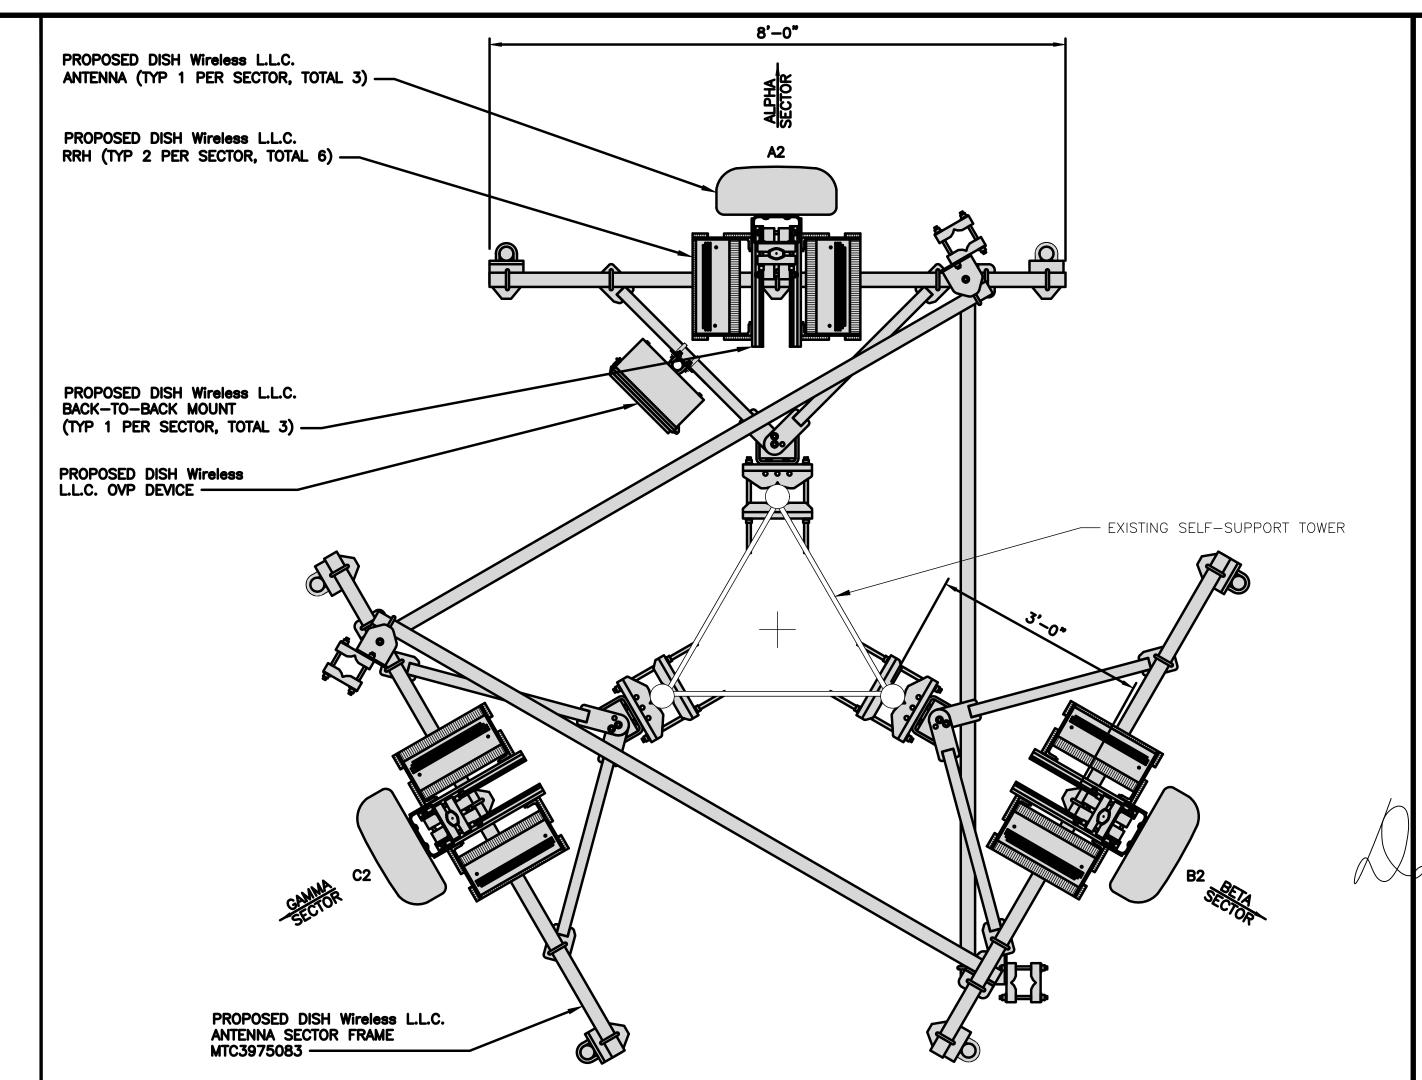
SHEET NUMBER

ENLARGED SITE PLANS

A-1

OVERALL UTILITY ROUTE PLAN





ANTENNA TRANSMISSION CABLE RRH OVP **SECTOR** FEED LINE TYPE AND LENGTH EXISTING OR PROPOSED MANUFACTURER - MODEL RAD CENTER MANUFACTURER - MODEL MANUFACTURER POS. TECH **AZIMUTH** TECH POS. NUMBER NUMBER MODEL FUJITSU / TA08025-B604 **A1** 5G **A2** HIGH-CAPACITY RAYCAP / RDIDC-9181-5G 330° 122'-0" HYBRID CABLE 5G **A2 A2** COMMSCOPE-FFW-65B-R2 FUJITSU / TA08025-B605 **PROPOSED** (155' LONG) PF-48 **A3** FUJITSU / TA08025-B604 5G **B2 B1** ----SHARED COMMSCOPE-FFW-65B-R2 5G 80° 122'-0" SHARED W/ALPHA 5G **B2 B2** FUJITSU / TA08025-B605 **PROPOSED** W/ALPHA ----

SHARED W/ALPHA

<u>NOTES</u>

C2

C3

PROPOSED

1. CONTRACTOR TO REFER TO FINAL CONSTRUCTION RFDS FOR ALL RF DETAILS.

COMMSCOPE-FFW-65B-R2

ANTENNA AND RRH MODELS MAY CHANGE DUE TO EQUIPMENT AVAILABILITY. ALL EQUIPMENT CHANGES MUST BE APPROVED AND REMAIN IN COMPLIANCE WITH THE PROPOSED DESIGN AND STRUCTURAL ANALYSES.

ANTENNA LAYOUT

--

5G

__

180°


122'-0"



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	PS		SMA		DPH		
	RFDS F	REV ;	#:			0	

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	BOBOSO0592A							
		D000002A						

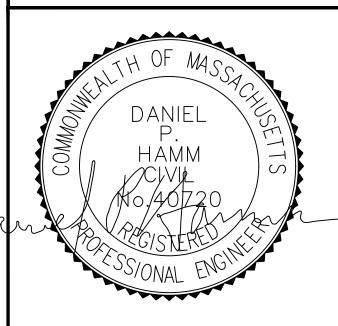DISH Wireless L.L.C. PROJECT INFORMATION B0B0S00592A CROWN CASTLE BU#841273 344 ROUTE 6

NORTH TRURO, MA 02652 SHEET TITLE

ELEVATION, ANTENNA LAYOUT AND SCHEDULE

SHEET NUMBER

A-2

ANTENNA SCHEDULE

NO SCALE

SHARED

W/ALPHA

3/4"=1'-0"

C2

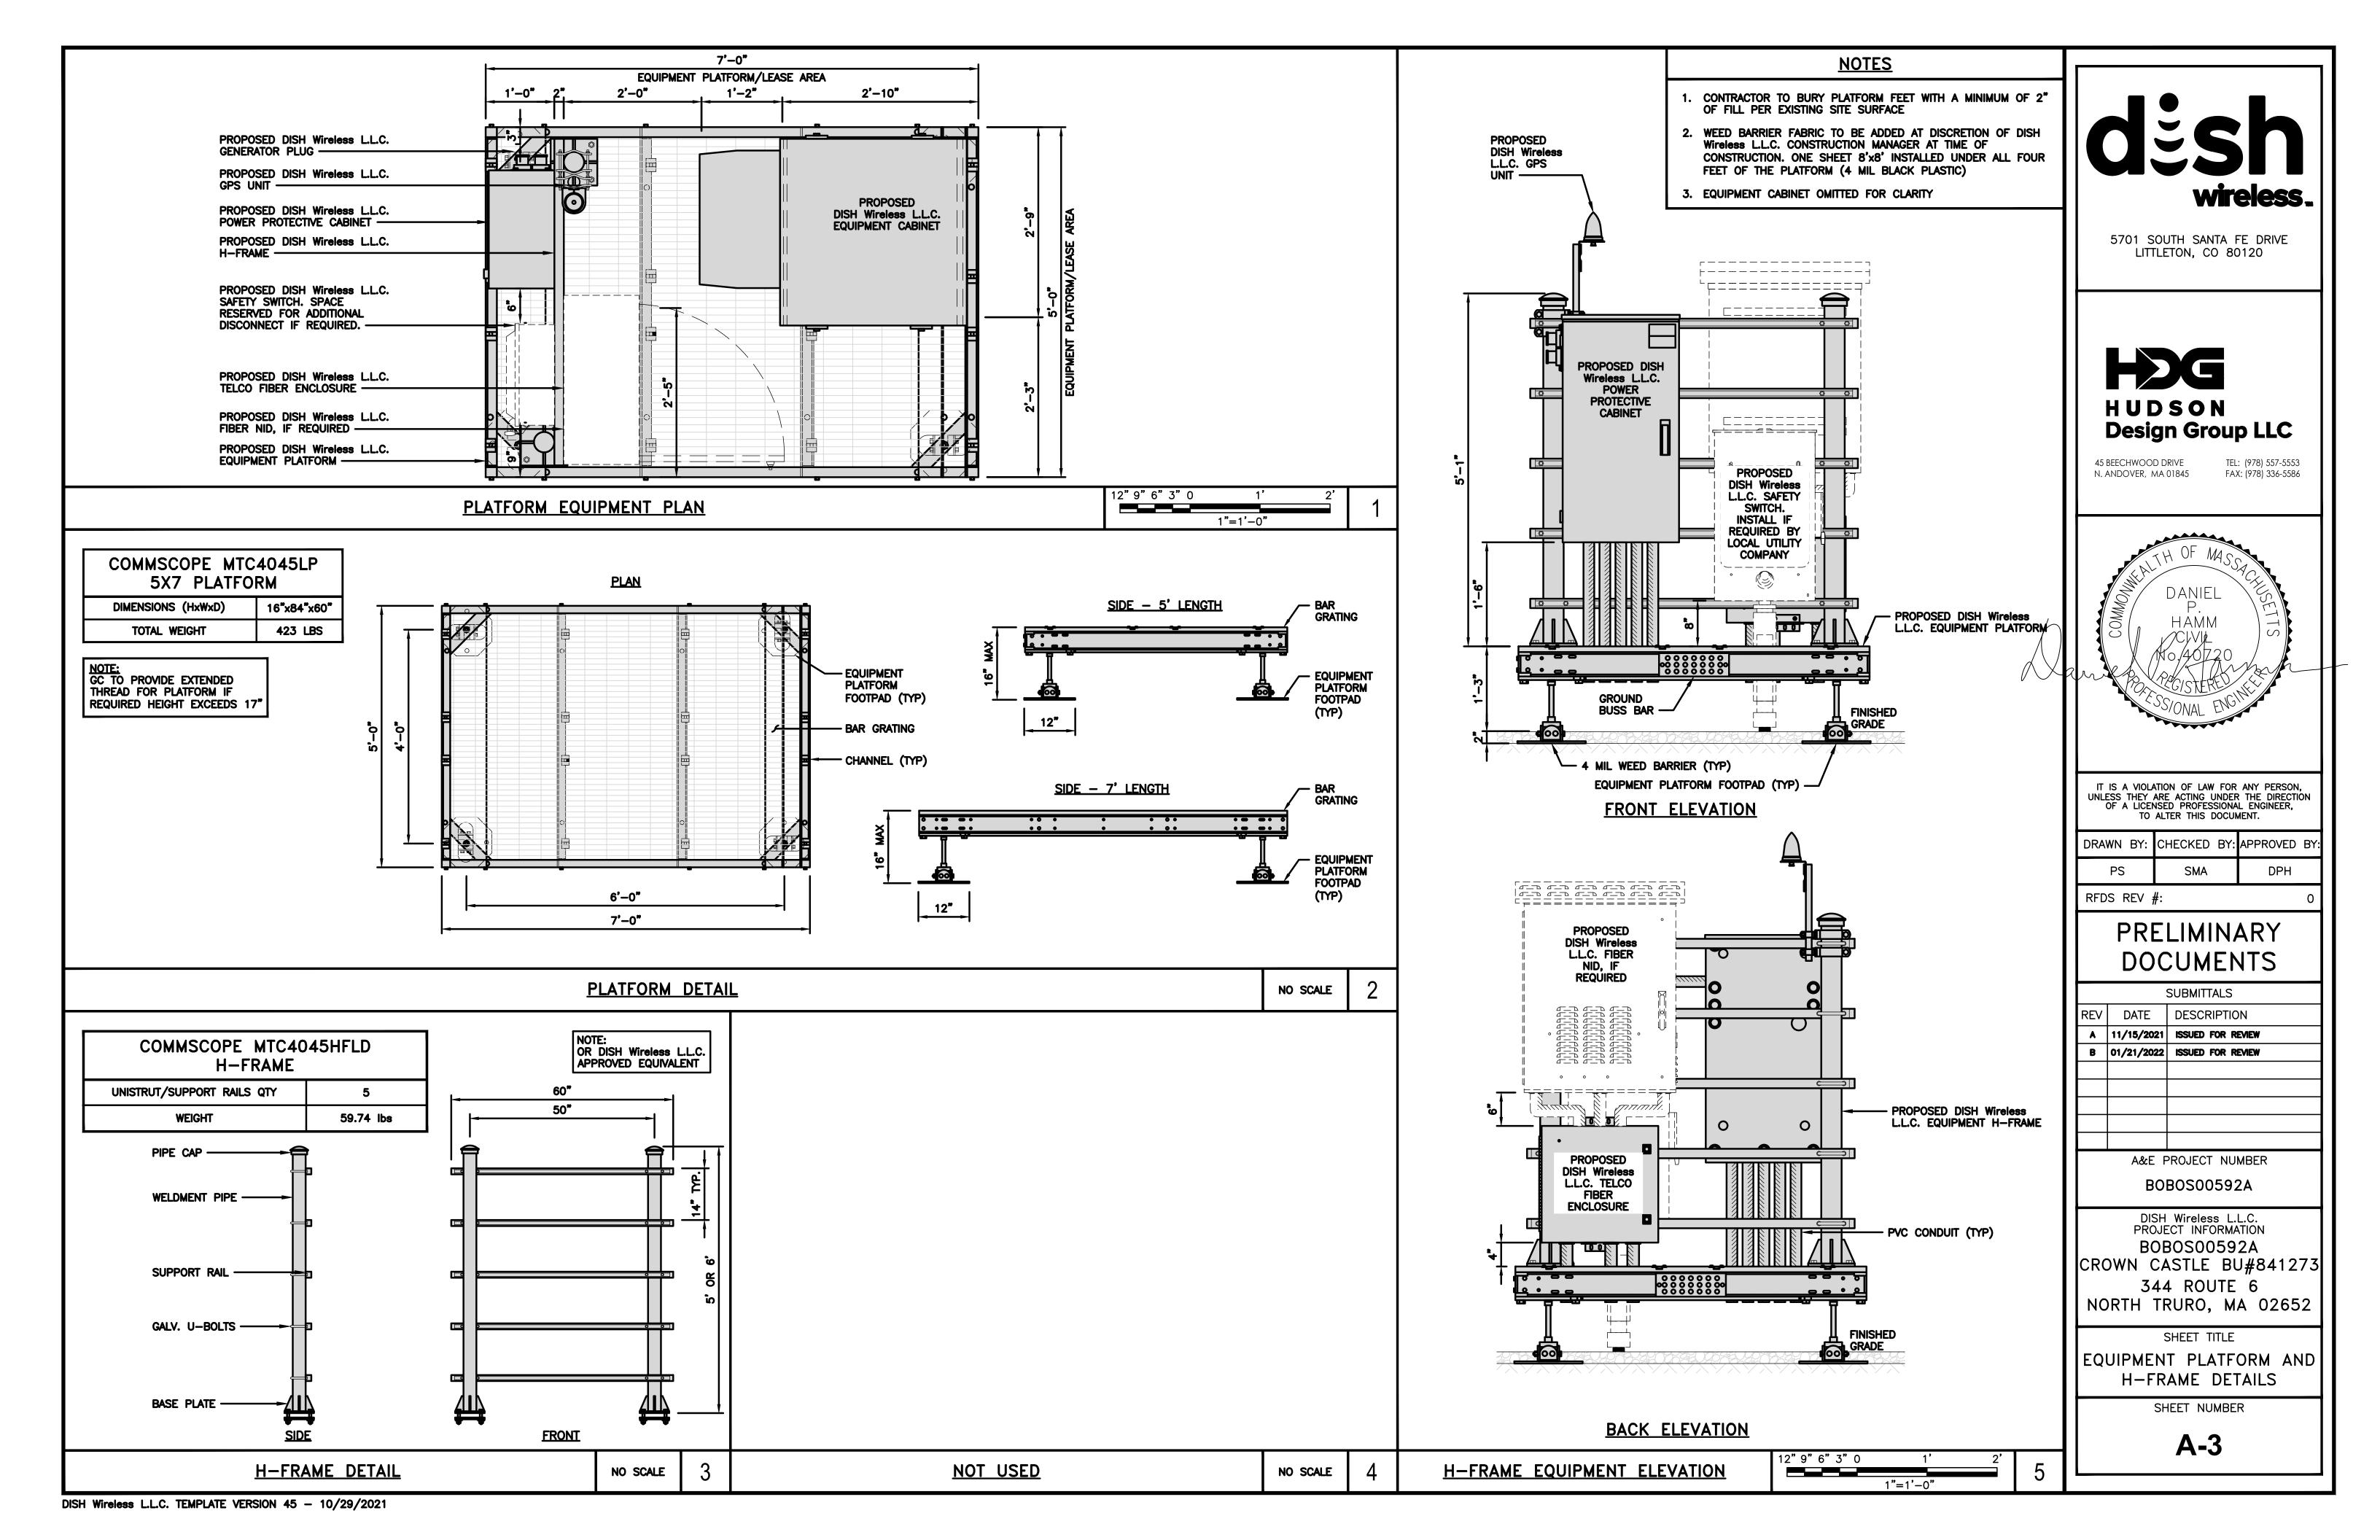
C2

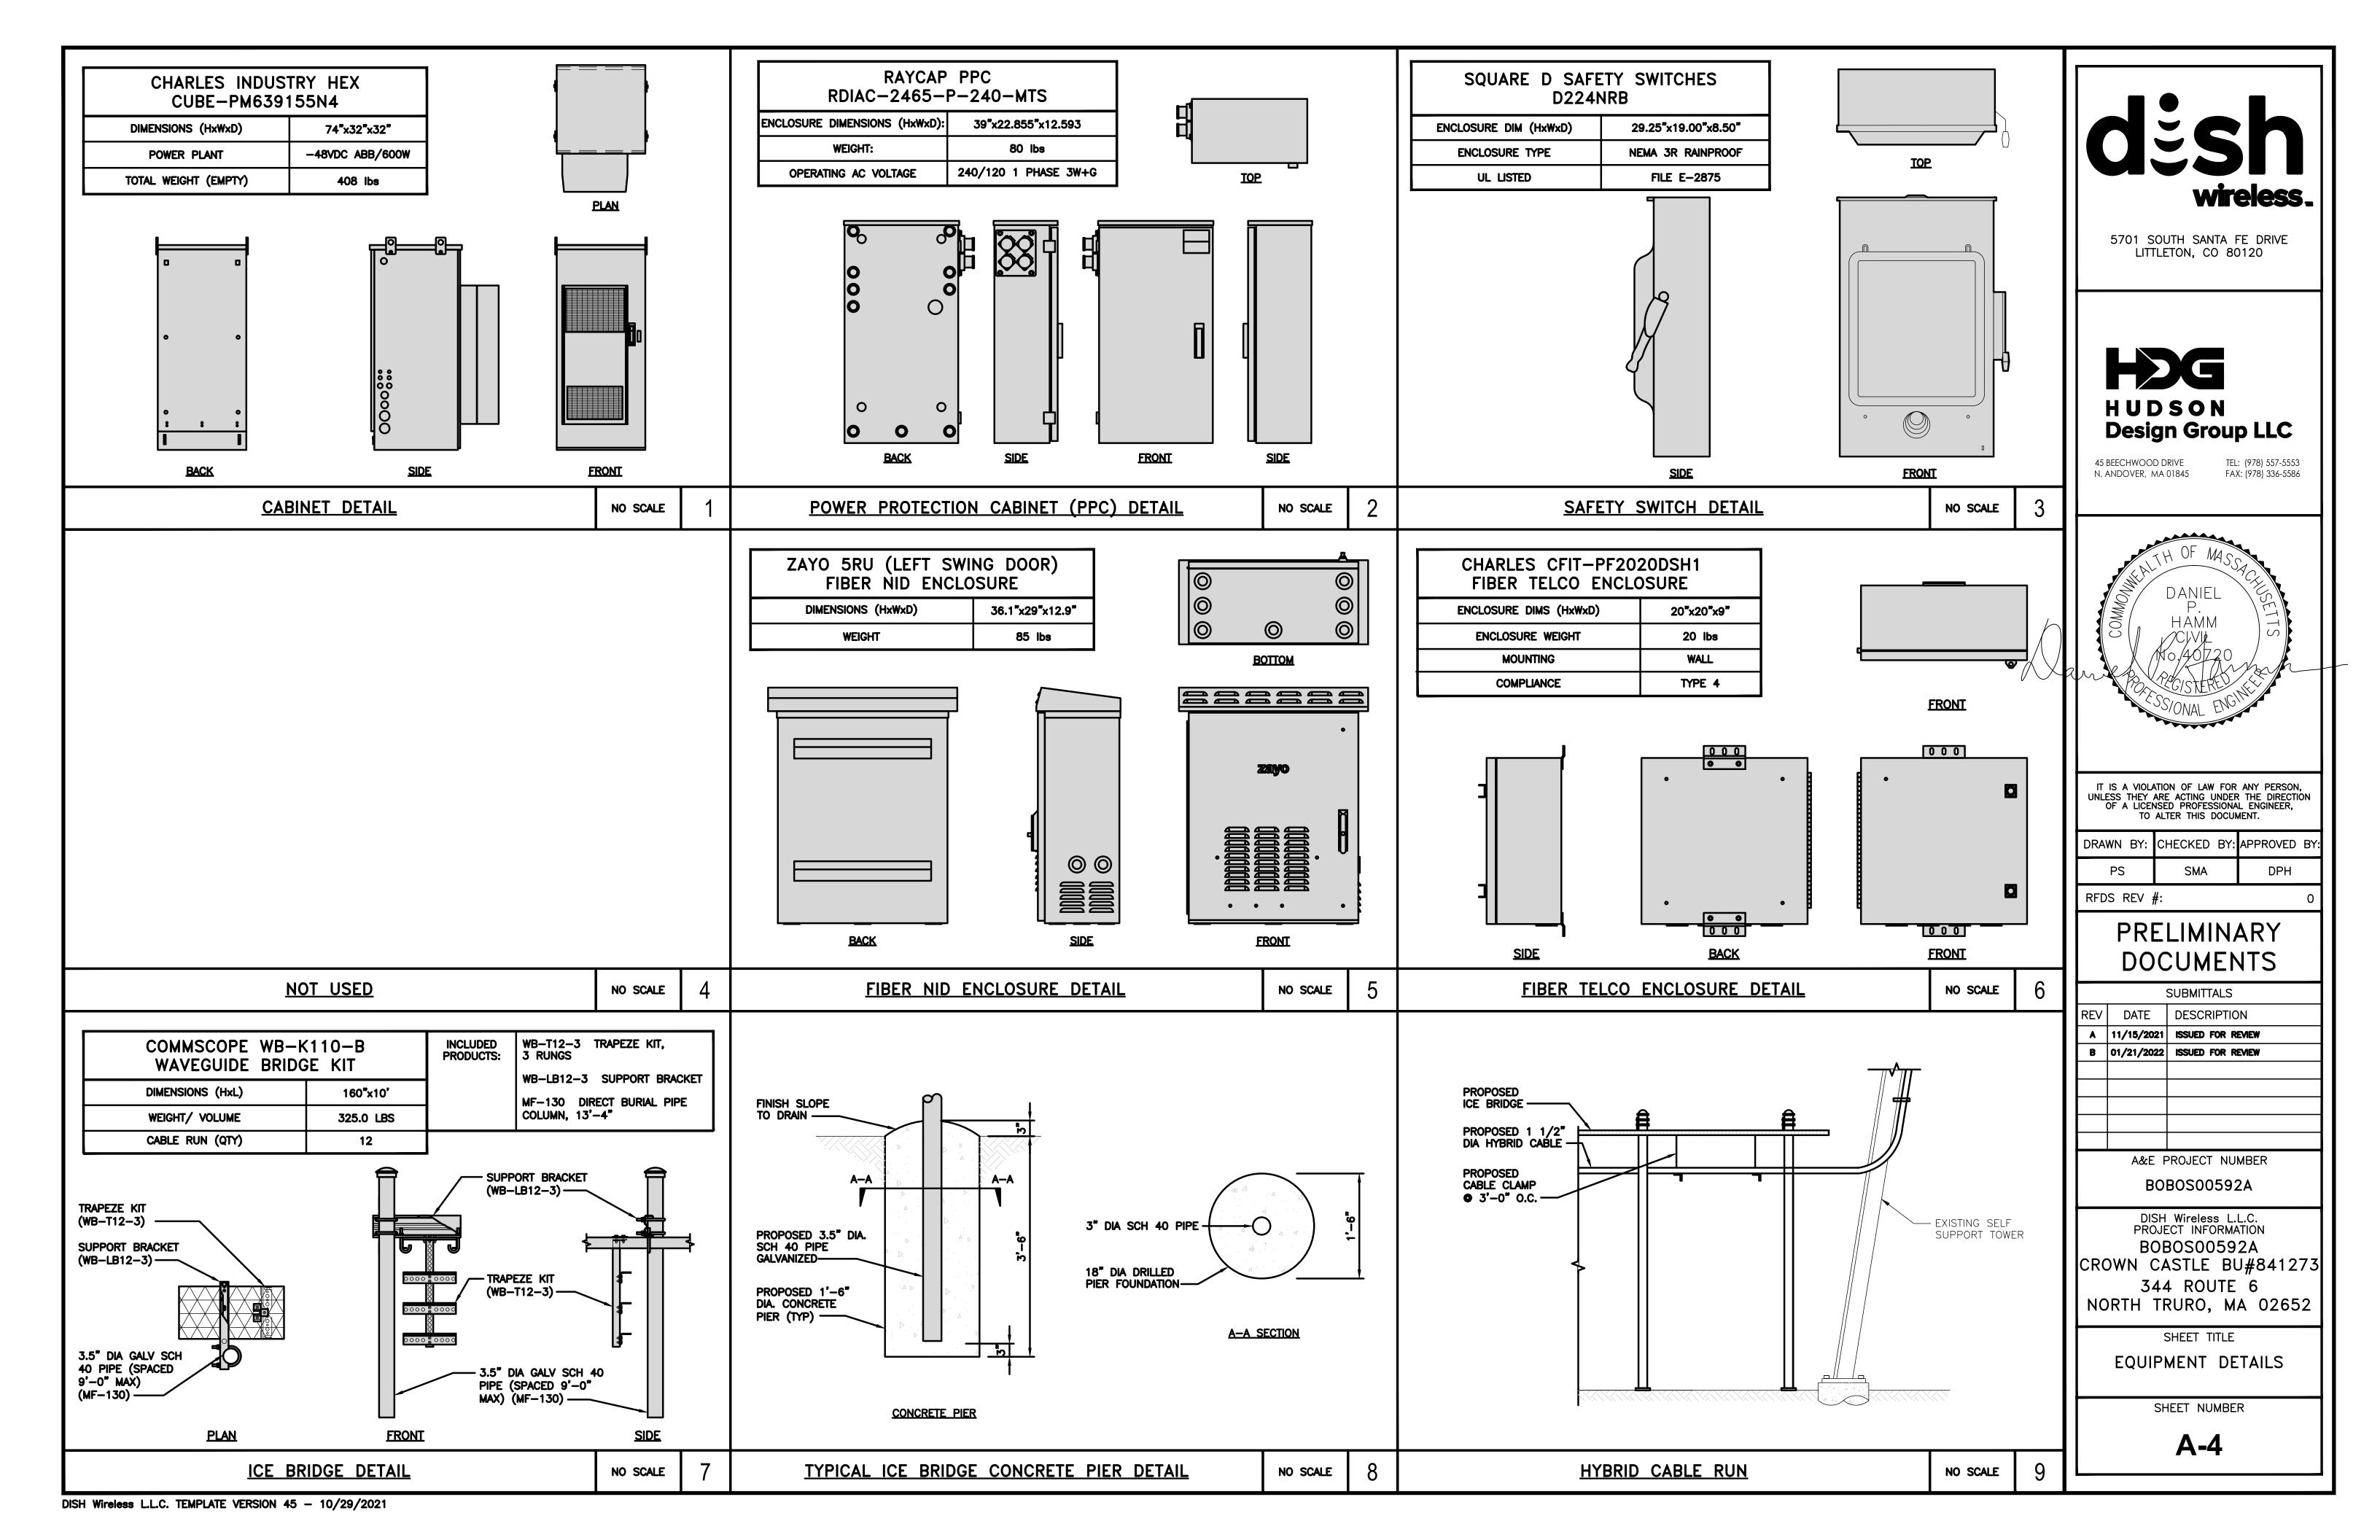
5G

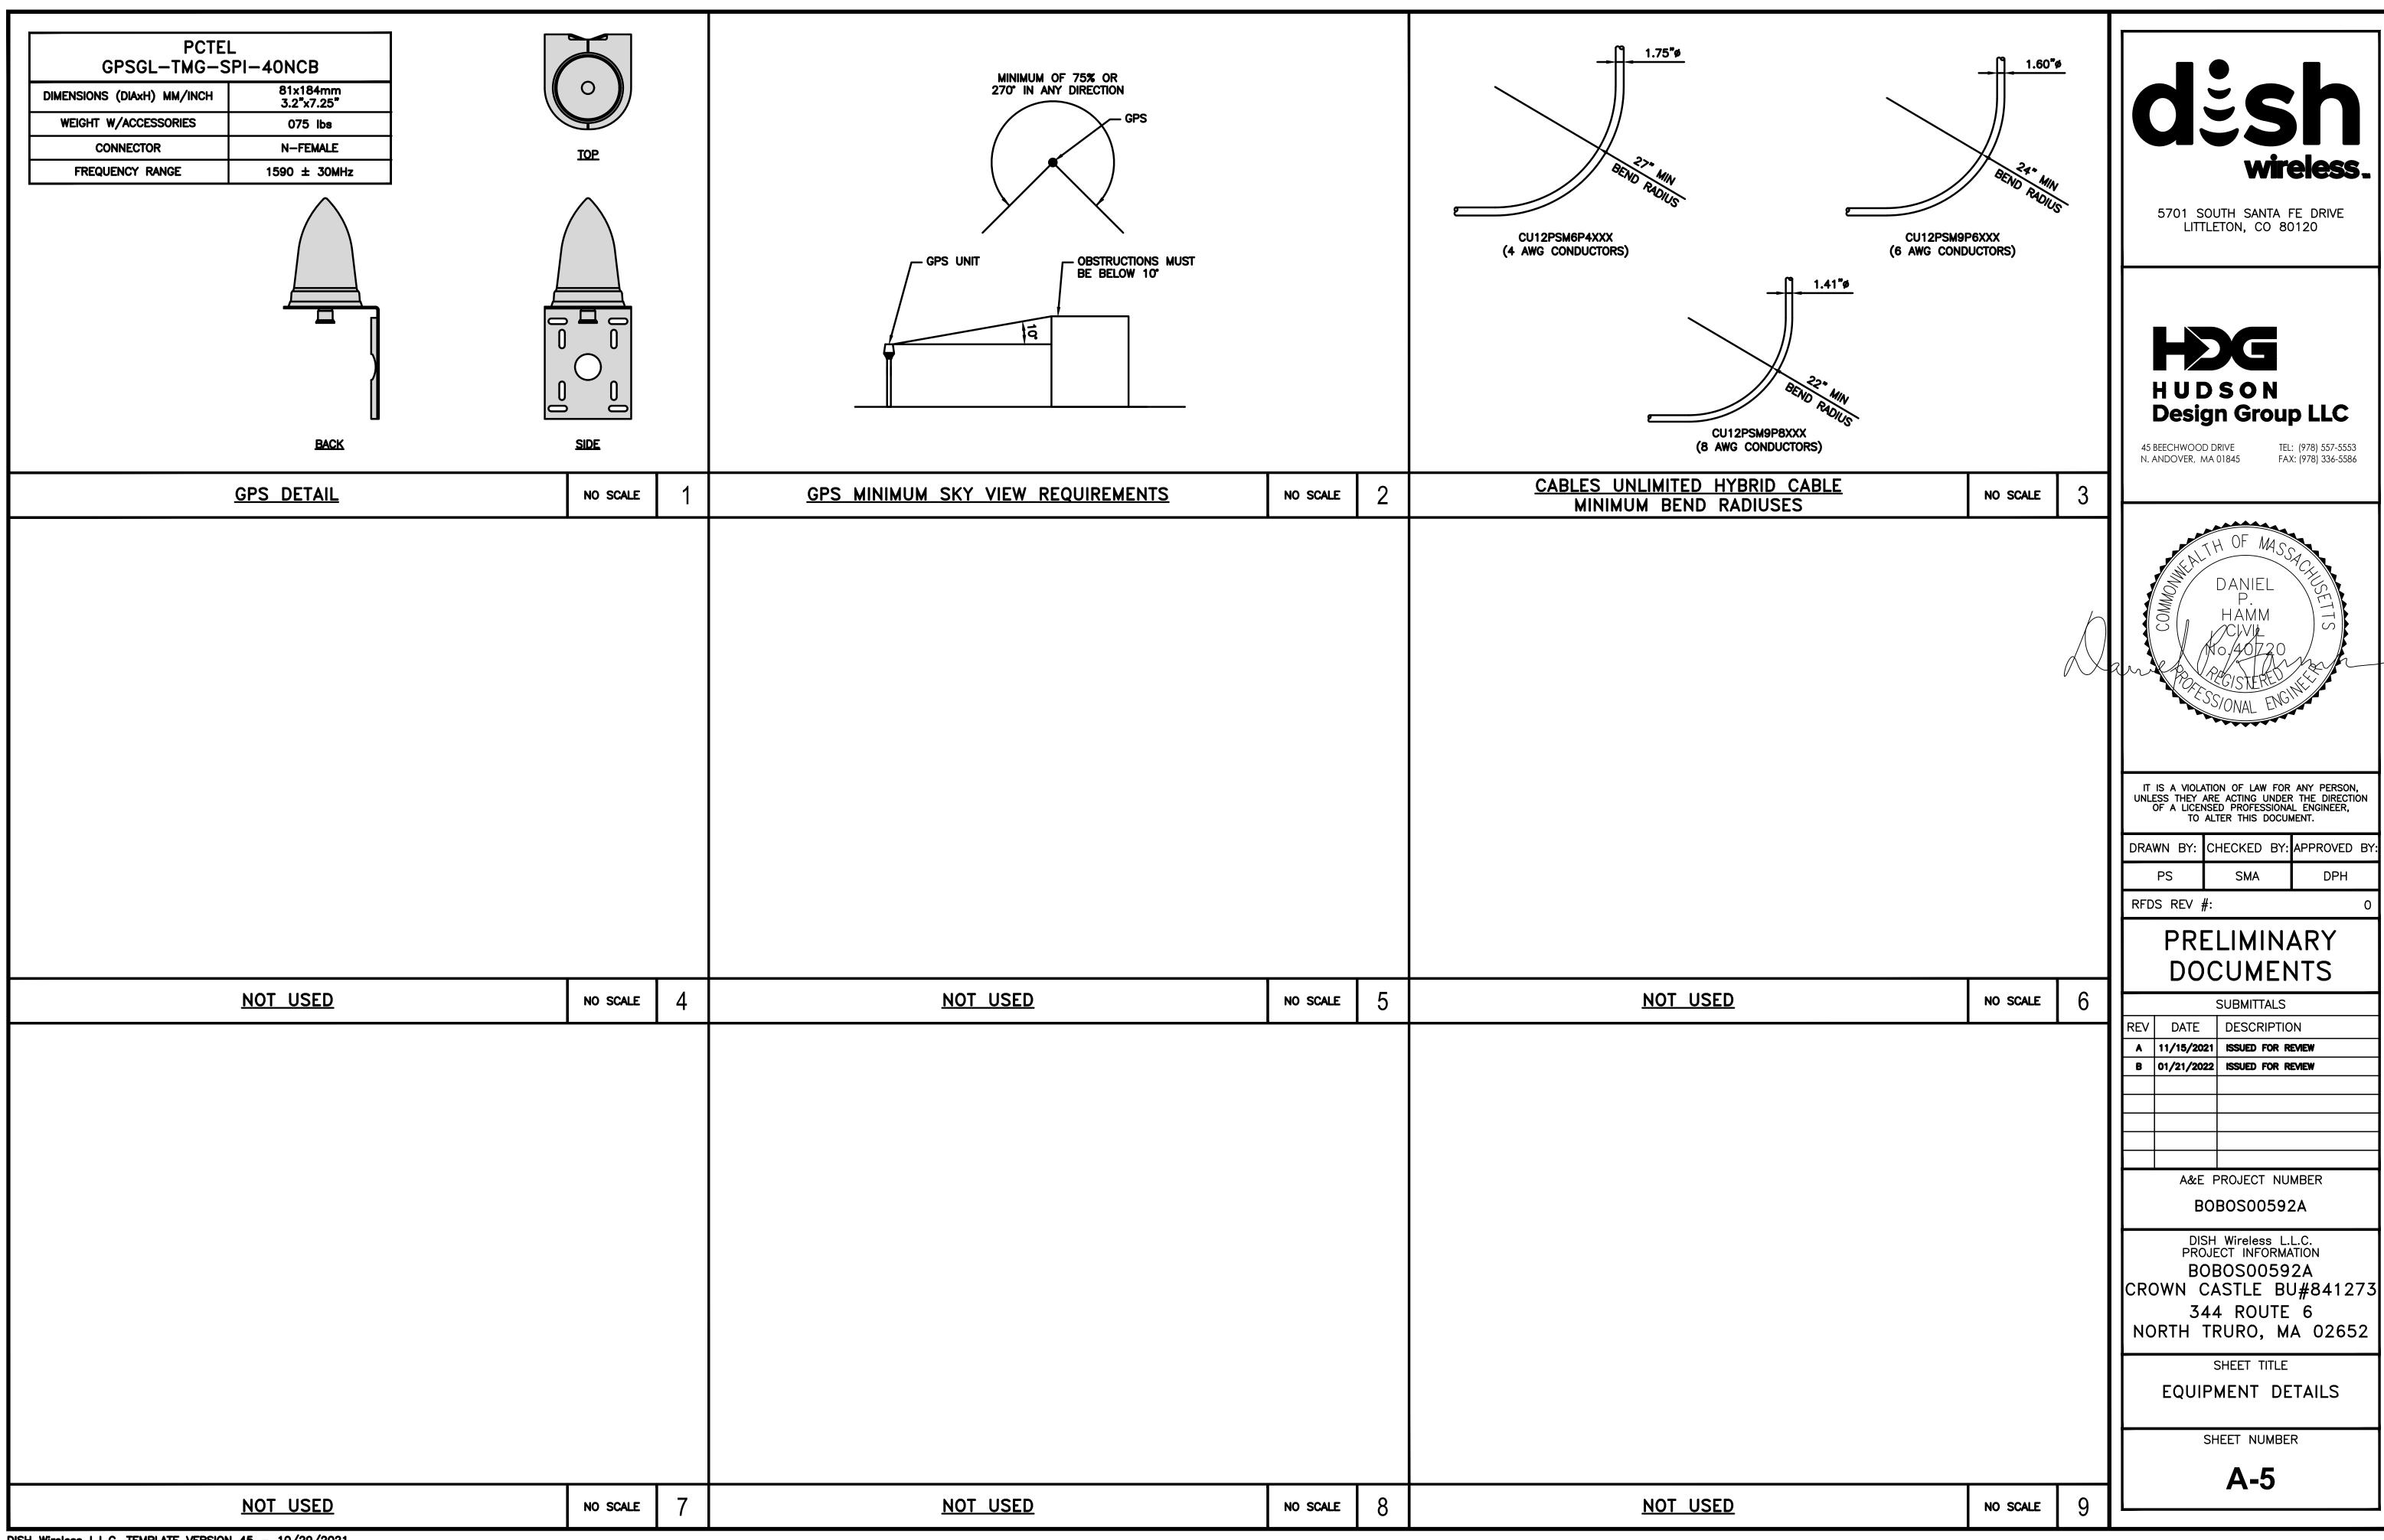
5G

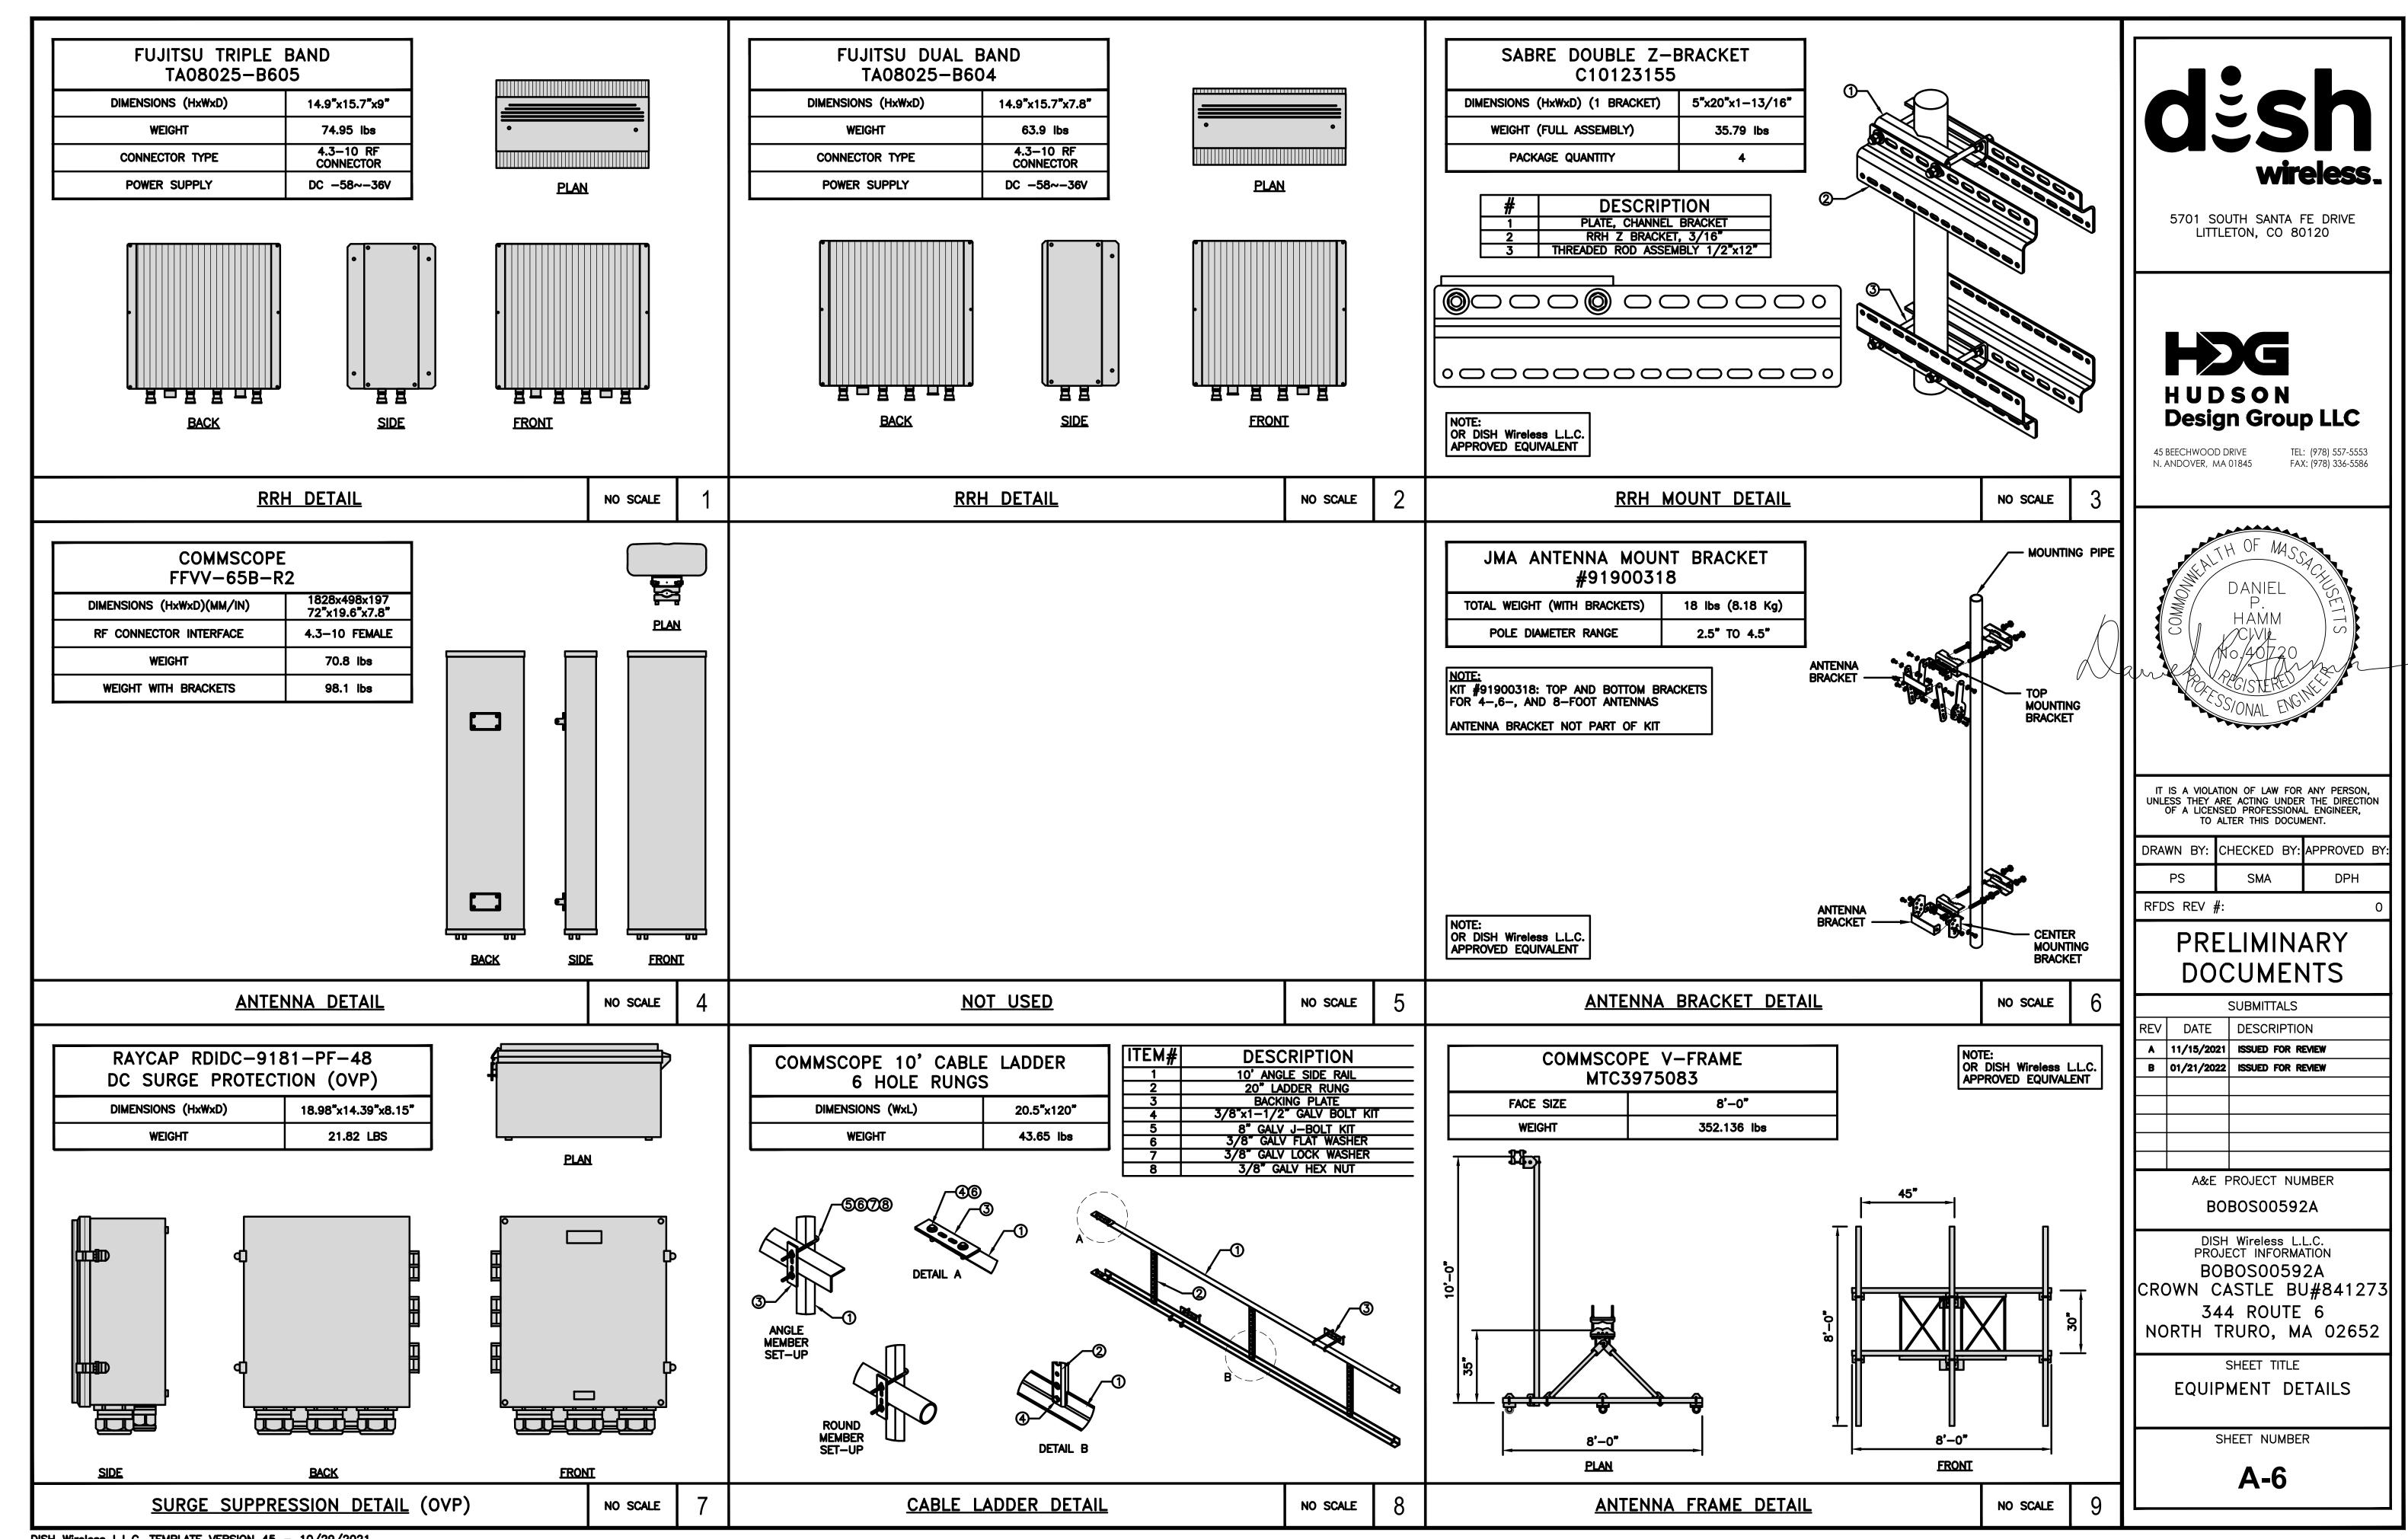
FUJITSU / TA08025-B604

FUJITSU / TA08025-B605










NOTES

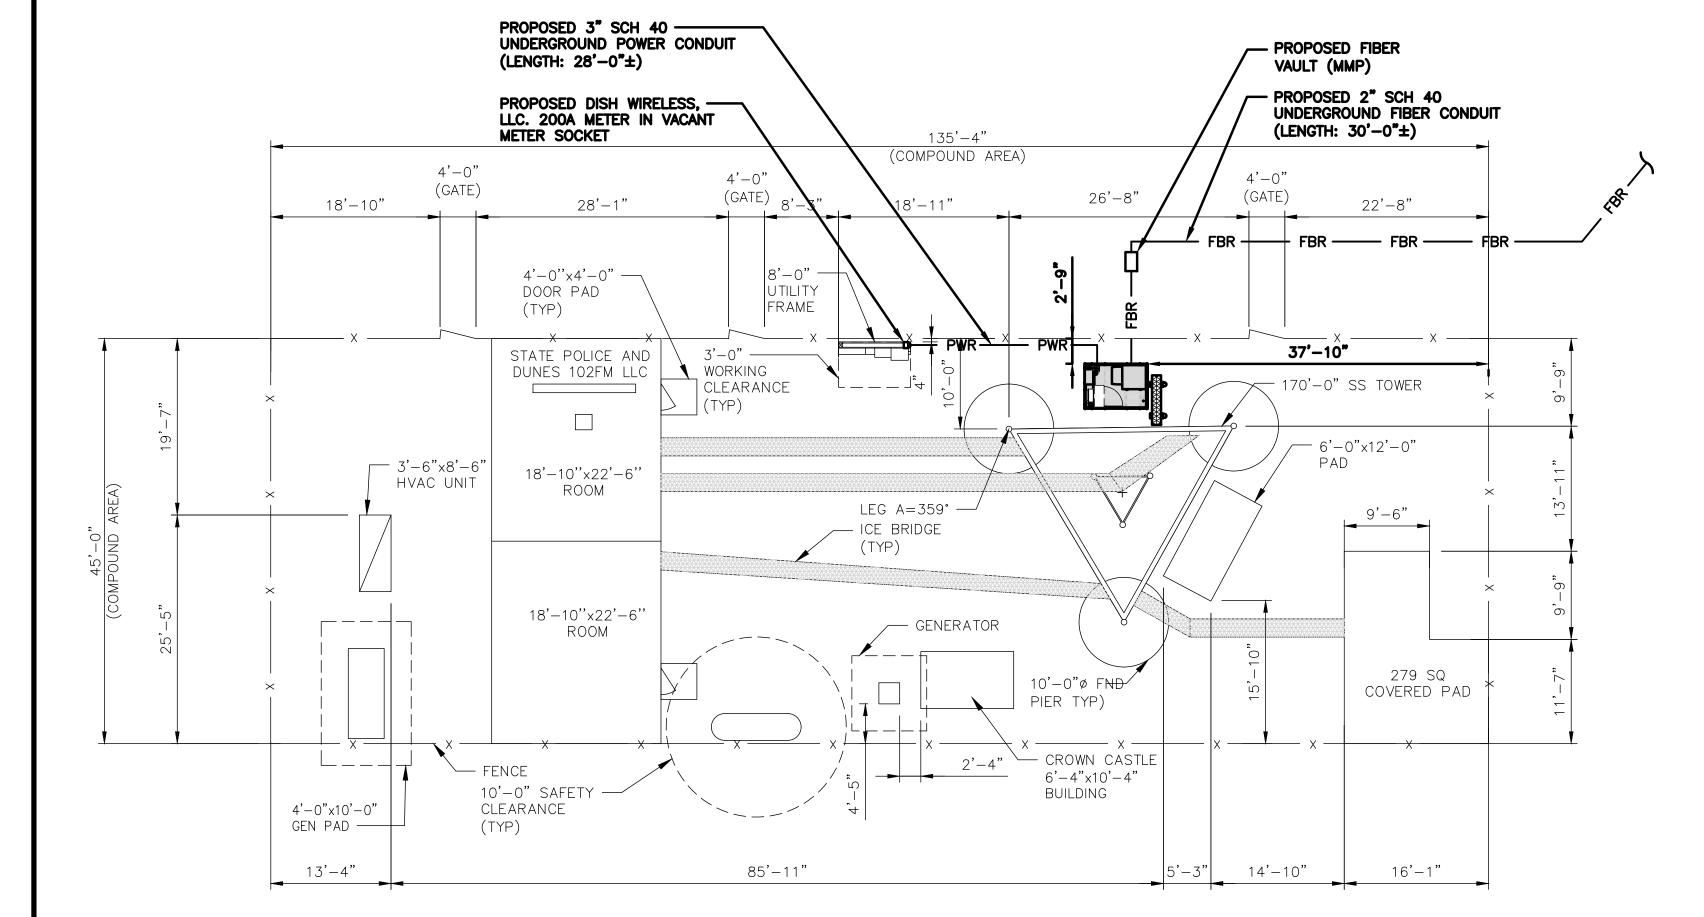- CONTRACTOR SHALL FIELD VERIFY ALL PROPOSED UNDERGROUND UTILITY CONDUIT ROUTE.
- 2. ANTENNAS AND MOUNTS OMITTED FOR CLARITY.
- 3. DUE TO UTILITY EASEMENT RIGHTS SPECIFIED IN THE GROUND LEASE, CUSTOMER MAY INSTALL EQUIPMENT WITHIN SPECIFIED UTILITY EASEMENT AREA. "PWR" AND "FBR" PATH DEPICTED ON A-1 AND E-1 REPRESENT PLANNED ROUTING BASED ON BEST AVAILABLE INFORMATION INCLUDING BUT NOT LIMITED TO A SURVEY, EXHIBITS, METES AND BOUNDS OF THE UTILITY EASEMENT, FIELD VERIFICATION, PRIOR PROJECT DOCUMENTATION AND OTHER REAL PROPETY RIGHTS DOCUMENTS. WHEN INSTALLING THE UTILITIES PLEASE LOCATE AND FOLLOW EXISTING PATH. IF EXISTING PATH IS MATERIALLY INCONSISTENT WITH "PWR" AND "FBR" PATH DEPICTED ON A-1 AND E-1 AND SAID VARIANCE IS NOT NOTED ON CDs, PLEASE NOTIFY TOWER OWNER AS FURTHER COORDINATION MAY BE NEEDED.



DC POWER WIRING SHALL BE COLOR CODED AT EACH END FOR IDENTIFYING +24V AND -48V CONDUCTORS. RED MARKINGS SHALL IDENTIFY +24V AND BLUE MARKINGS SHALL IDENTIFY -48V.

- CONTRACTOR SHALL INSPECT THE EXISTING CONDITIONS PRIOR TO SUBMITTING A BID. ANY QUESTIONS ARISING DURING THE BID PERIOD IN REGARDS TO THE CONTRACTOR'S FUNCTIONS, THE SCOPE OF WORK, OR ANY OTHER ISSUE RELATED TO THIS PROJECT SHALL BE BROUGHT UP DURING THE BID PERIOD WITH THE PROJECT MANAGER FOR CLARIFICATION, NOT AFTER THE CONTRACT HAS BEEN AWARDED.
- 2. ALL ELECTRICAL WORK SHALL BE DONE IN ACCORDANCE WITH CURRENT NATIONAL ELECTRICAL CODES AND ALL STATE AND LOCAL CODES, LAWS, AND ORDINANCES. PROVIDE ALL COMPONENTS AND WIRING SIZES AS REQUIRED TO MEET NEC STANDARDS.
- 3. LOCATION OF EQUIPMENT, CONDUIT AND DEVICES SHOWN ON THE DRAWINGS ARE APPROXIMATE AND SHALL BE COORDINATED WITH FIELD CONDITIONS PRIOR TO CONSTRUCTION.
- 4. CONDUIT ROUGH-IN SHALL BE COORDINATED WITH THE MECHANICAL EQUIPMENT TO AVOID LOCATION CONFLICTS. VERIFY WITH THE MECHANICAL EQUIPMENT CONTRACTOR AND COMPLY AS REQUIRED.
- 5. CONTRACTOR SHALL PROVIDE ALL BREAKERS, CONDUITS AND CIRCUITS AS REQUIRED FOR A COMPLETE SYSTEM.
- 6. CONTRACTOR SHALL PROVIDE PULL BOXES AND JUNCTION BOXES AS REQUIRED BY THE NEC ARTICLE 314.
- 7. CONTRACTOR SHALL PROVIDE ALL STRAIN RELIEF AND CABLE SUPPORTS FOR ALL CABLE ASSEMBLIES. INSTALLATION SHALL BE IN ACCORDANCE WITH MANUFACTURER'S SPECIFICATIONS AND RECOMMENDATIONS.
- 8. ALL DISCONNECTS AND CONTROLLING DEVICES SHALL BE PROVIDED WITH ENGRAVED PHENOLIC NAMEPLATES INDICATING EQUIPMENT CONTROLLED, BRANCH CIRCUITS INSTALLED ON, AND PANEL FIELD LOCATIONS FED FROM.
- 9. INSTALL AN EQUIPMENT GROUNDING CONDUCTOR IN ALL CONDUITS PER THE SPECIFICATIONS AND NEC 250. THE EQUIPMENT GROUNDING CONDUCTORS SHALL BE BONDED AT ALL JUNCTION BOXES, PULL BOXES, AND ALL DISCONNECT SWITCHES, AND EQUIPMENT CABINETS.
- 10. ALL NEW MATERIAL SHALL HAVE A U.L. LABEL.
- 11. PANEL SCHEDULE LOADING AND CIRCUIT ARRANGEMENTS REFLECT POST—CONSTRUCTION EQUIPMENT.
- 12. CONTRACTOR SHALL BE RESPONSIBLE FOR AS-BUILT PANEL SCHEDULE AND SITE DRAWINGS.

ELECTRICAL NOTES

13. ALL TRENCHES IN COMPOUND TO BE HAND DUG

TRURO PROPOSED FIBER HANDHOLE PROPOSED 2" SCH 40 UNDERGROUND FIBER CONDUIT (LENGTH: 439'-0"±) (ASSUMED FIBER ROUTE ACTUAL FIBER ROUTE TBD)


NO SCALE

wireless.

5701 SOUTH SANTA FE DRIVE LITTLETON, CO 80120



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DRAWN BY: CHECKED BY: APPROVED BY PS

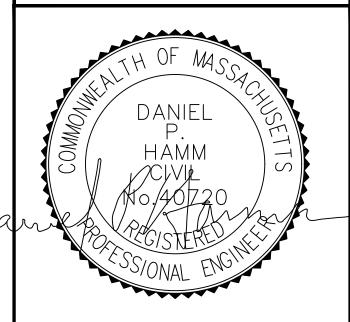RFDS REV #:

PRELIMINARY DOCUMENTS

SUBMITTALS

REV DATE DESCRIPTION

A 11/15/2021 ISSUED FOR REVIEW B 01/21/2022 ISSUED FOR REVIEW A&E PROJECT NUMBER BOBOSO0592A

DISH Wireless L.L.C. PROJECT INFORMATION B0B0S00592A CROWN CASTLE BU#841273

344 ROUTE 6 NORTH TRURO, MA 02652

SHEET TITLE

ELECTRICAL/FIBER ROUTE PLAN AND NOTES

SHEET NUMBER

E-1

UTILITY ROUTE PLAN

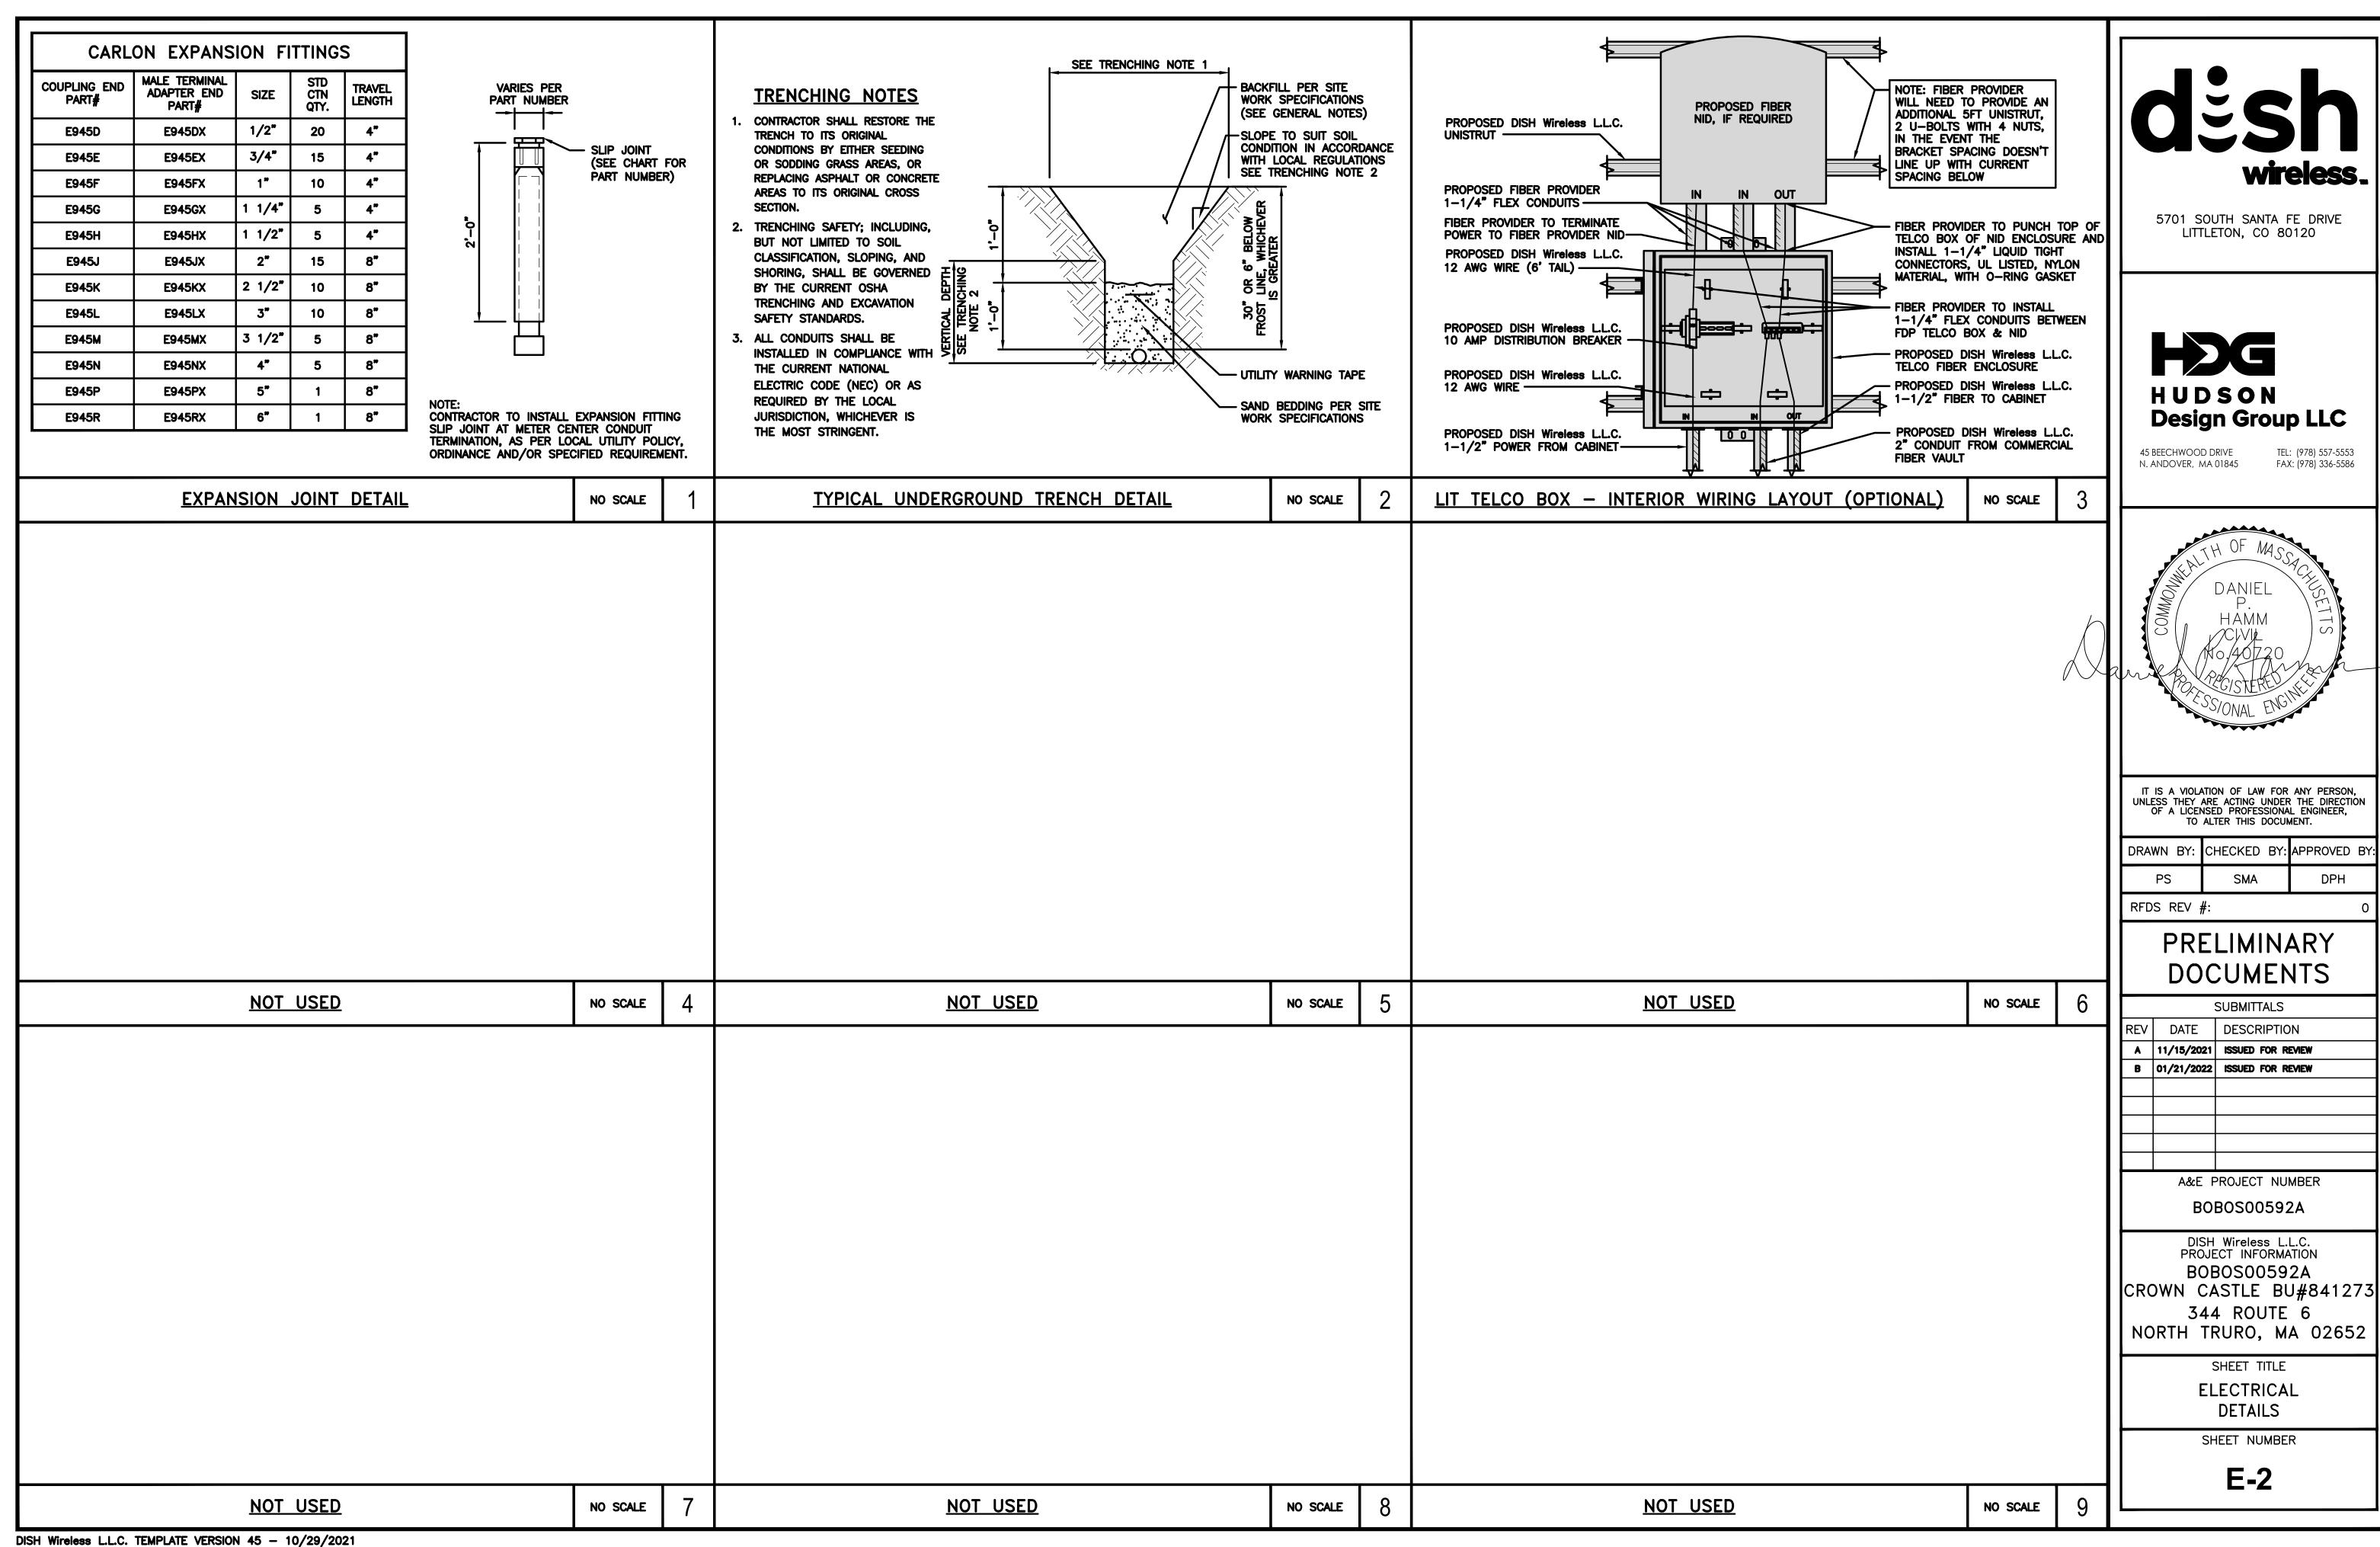
12' 8' 4' 0 3/32"=1'-0"

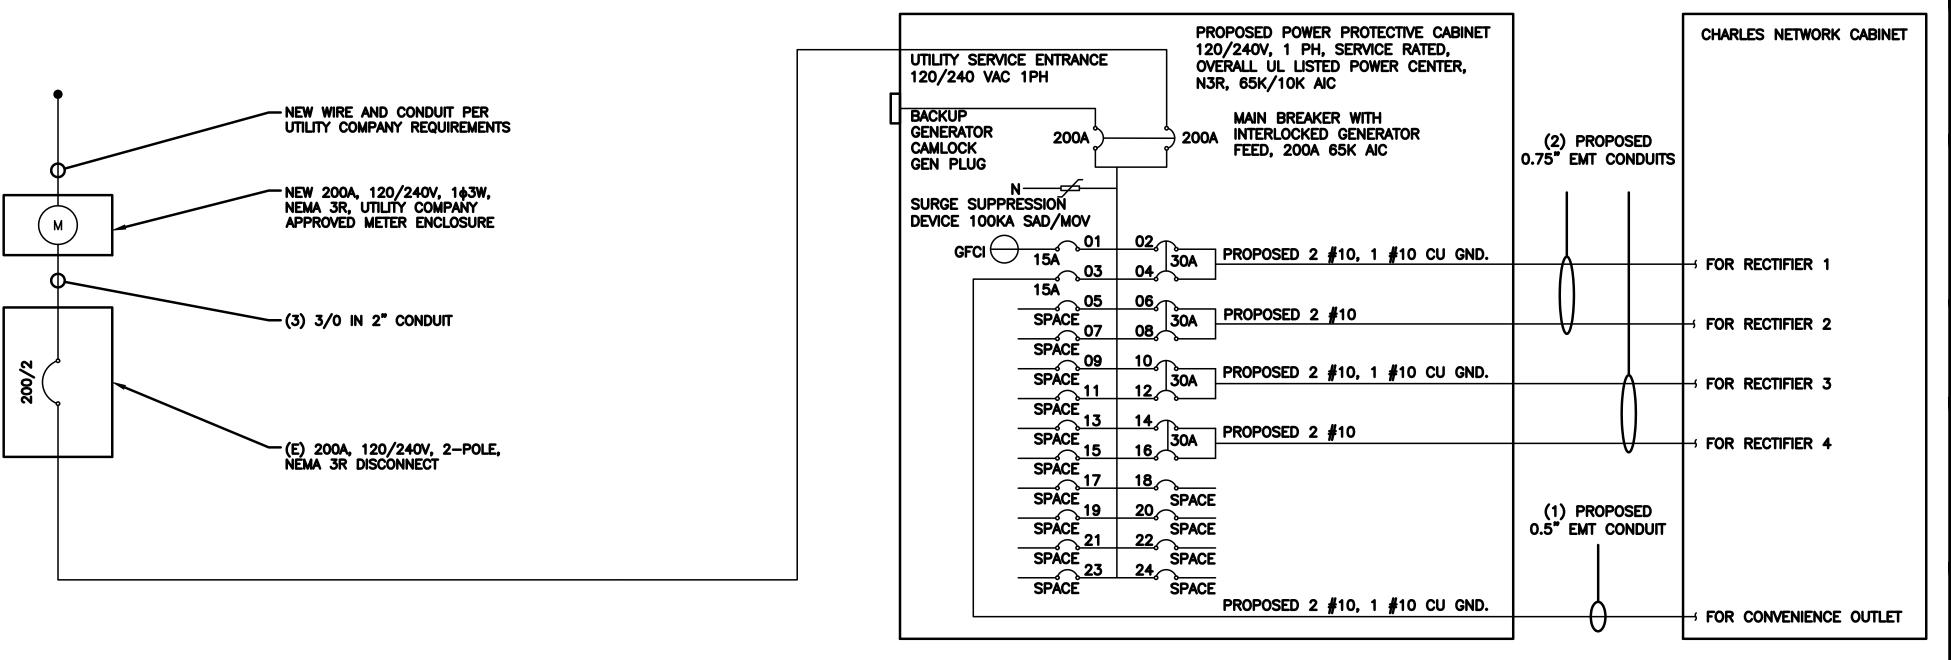
OVERALL UTILITY ROUTE PLAN

DISH Wireless L.L.C. TEMPLATE VERSION 45 - 10/29/2021

(SEE NOTE 3)

PROPOSED FIBER VAULT (MMP)





BREAKERS REQUIRED:

(4) 30A, 2P BREAKER - SQUARE D P/N:Q0230 (1) 15A, 1P BREAKER - SQUARE D P/N:Q0115 <u>NOTES</u>

THE ENGINEER OF RECORD HAS PERFORMED ALL REQUIRED SHORT CIRCUIT CALCULATIONS AND THE AIC RATINGS FOR EACH DEVICE IS ADEQUATE TO PROTECT THE EQUIPMENT AND THE ELECTRICAL SYSTEM.

THE ENGINEER OF RECORD HAS PERFORMED ALL REQUIRED VOLTAGE DROP CALCULATIONS AND ALL BRANCH CIRCUIT AND FEEDERS COMPLY WITH THE NEC (LISTED ON T-1) ARTICLE 210.19(A)(1) FPN NO. 4.

THE (2) CONDUITS WITH (4) CURRENT CARRYING CONDUCTORS EACH, SHALL APPLY THE ADJUSTMENT FACTOR OF 80% PER 2014/17 NEC TABLE 310.15(B)(3)(a) OR 2020 NEC TABLE 310.15(C)(1) FOR UL1015 WIRE.

#12 FOR 15A-20A/1P BREAKER: 0.8 x 30A = 24.0A #10 FOR 25A-30A/2P BREAKER: 0.8 x 40A = 32.0A #8 FOR 35A-40A/2P BREAKER: 0.8 x 55A = 44.0A #6 FOR 45A-60A/2P BREAKER: 0.8 x 75A = 60.0A

CONDUIT SIZING: AT 40% FILL PER NEC CHAPTER 9, TABLE 4, ARTICLE 358.

0.5" CONDUIT - 0.122 SQ. IN AREA

0.75" CONDUIT — 0.213 SQ. IN AREA 2.0" CONDUIT — 1.316 SQ. IN AREA 3.0" CONDUIT — 2.907 SQ. IN AREA

CABINET CONVENIENCE OUTLET CONDUCTORS (1 CONDUIT): USING THWN-2, CU.

#10 - 0.0211 SQ. IN X 2 = 0.0422 SQ. IN #10 - 0.0211 SQ. IN X 1 = 0.0211 SQ. IN <GROUND

0.5" EMT CONDUIT IS ADEQUATE TO HANDLE THE TOTAL OF (3) WIRES, INCLUDING GROUND WIRE, AS INDICATED ABOVE.

RECTIFIER CONDUCTORS (2 CONDUITS): USING UL1015, CU.

#10 - 0.0266 SQ. IN X 4 = 0.1064 SQ. IN #10 - 0.0082 SQ. IN X 1 = 0.0082 SQ. IN <BARE GROUND TOTAL = 0.1146 SQ. IN

= 0.0633 SQ. IN

0.75" EMT CONDUIT IS ADEQUATE TO HANDLE THE TOTAL OF (5) WIRES, INCLUDING GROUND WIRE, AS INDICATED ABOVE.

PPC FEED CONDUCTORS (1 CONDUIT): USING THWN, CU.

3/0 - 0.2679 SQ. IN X 3 = 0.8037 SQ. IN #6 - 0.0507 SQ. IN X 1 = 0.0507 SQ. IN <GROUND

3.0" SCH 40 PVC CONDUIT IS ADEQUATE TO HANDLE THE TOTAL OF (4) WIRES, INCLUDING GROUND WIRE, AS INDICATED ABOVE.

= 0.8544 SQ. IN

PPC ONE-LINE DIAGRAM

NOTE:
BRANCH CIRCUIT WIRING SUPPLYING RECTIFIERS ARE TO BE RATED UL1015, 105°C, 600V, AND PVC INSULATED, IN THE SIZES SHOWN

IN THE ONE—LINE DIAGRAM. CONTRACTOR MAY SUBSTITUTE UL1015 WIRE FOR THWN—2 FOR CONVENIENCE OUTLET BRANCH CIRCUIT.

NO SCALE

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RFDS REV #:

DRAWN BY: CHECKED BY: APPROVED BY:
PS SMA DPH

PRELIMINARY DOCUMENTS

wireless.

TEL: (978) 557-5553

FAX: (978) 336-5586

5701 SOUTH SANTA FE DRIVE

LITTLETON, CO 80120

Design Group LLC

DANIEL

HAMM

HUDSON

45 BEECHWOOD DRIVE

N. ANDOVER, MA 01845

	SUBMITTALS						
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A&E PROJECT NUMBER
BOBOS00592A

DISH Wireless L.L.C.
PROJECT INFORMATION
BOBOS00592A
CROWN CASTLE BU#841273

344 ROUTE 6 NORTH TRURO, MA 02652

SHEET TITLE

ELECTRICAL ONE-LINE, FAULT CALCS & PANEL SCHEDULE

SHEET NUMBER

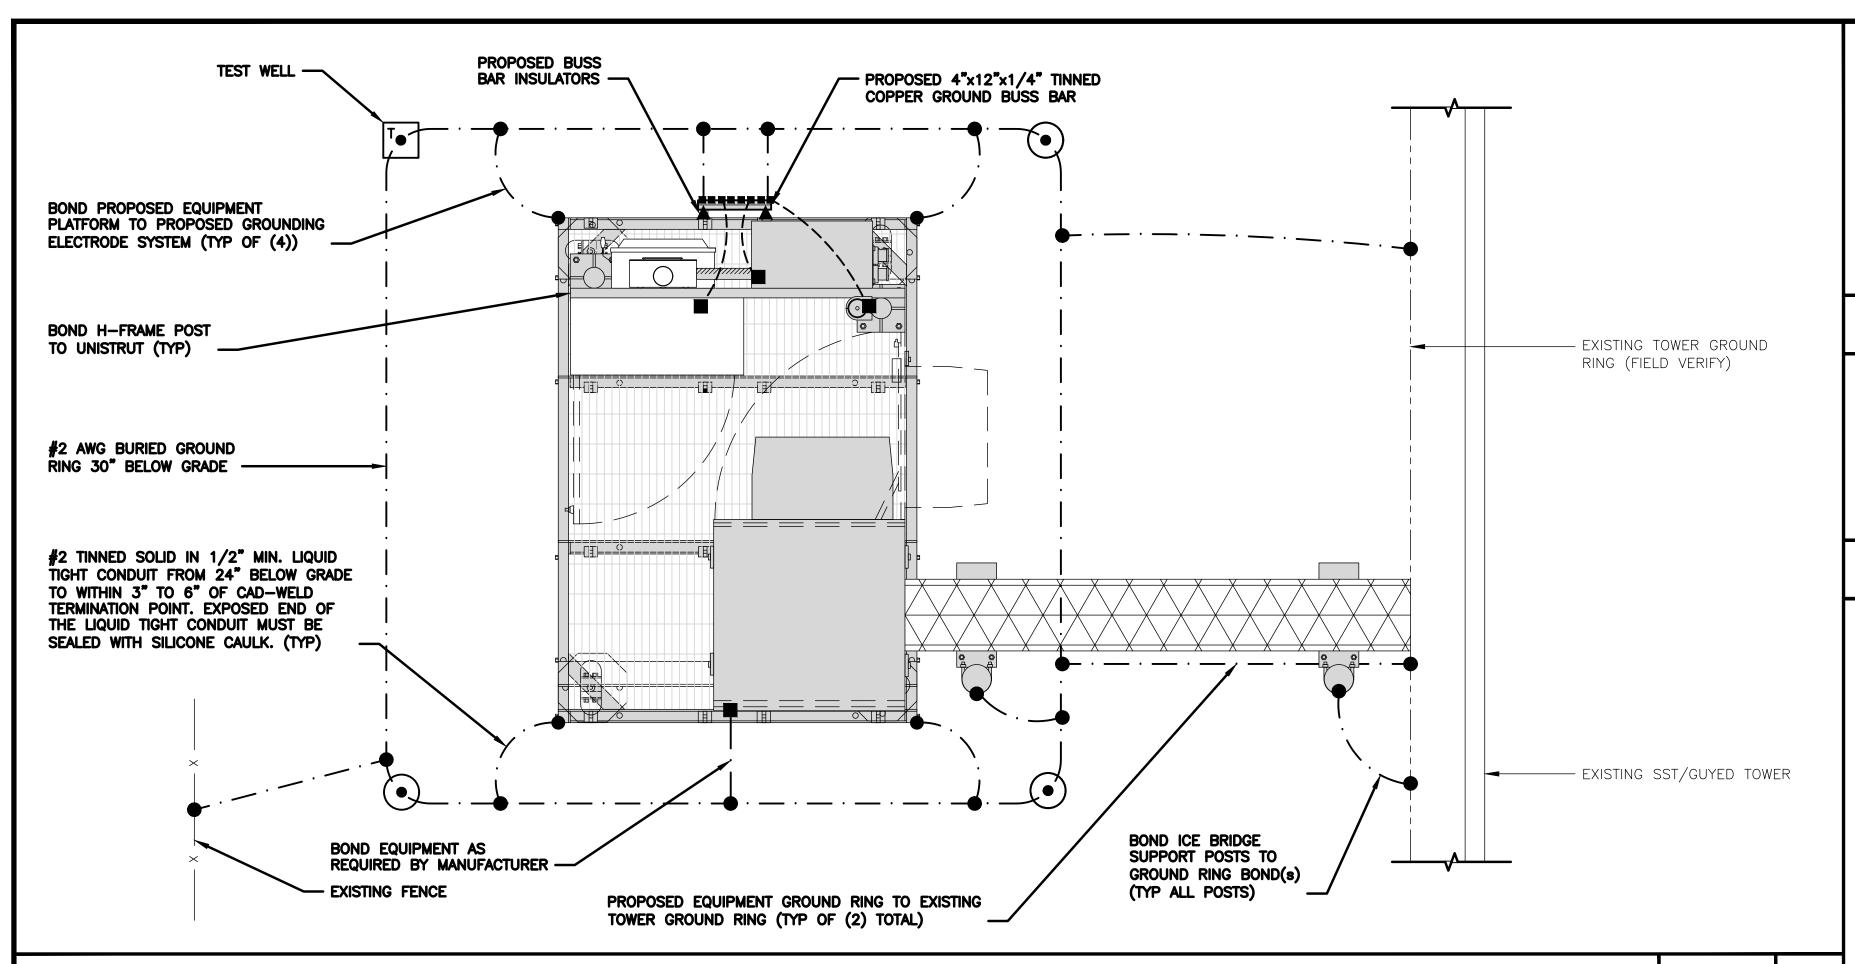
E-3

PROPOSED CHARLES PANEL SCHEDULE												
LOAD SERVED		AMPS TTS)	TRIP	CKT #	Р	HAS	E	CKT #	TRIP		AMPS TTS)	LOAD SERVED
DDO OFOL OUTLET	L1	L2	454			•				L1	L2	
PPC GFCI OUTLET CHARLES GFCI OUTLET	180	180	15A 15A	3	云	B	失	2	30A	2880	2880	ABB/GE INFINITY RECTIFIER 1
-SPACE-				5	7	A	4	6	30A	2880		ABB/GE INFINITY
-SPACE-				7	7	В	\langle	8	JUA		2880	RÉCTIFIER 2
-SPACE-				9	7	A	쉳	10	30A	2880		ABB/GE INFINITY
-SPACE-				11	7	В	\langle	12	JUA		2880	RÉCTIFIER 3
-SPACE-				13	7	Α	子	14	30A	2880		ABB/GE INFINITY
-SPACE-				15	7	В	\sum_{i}	16	JUA		2880	RÉCTIFIER 4
-SPACE-				17	abla	Α	\sim	18				-SPACE-
-SPACE-				19	\overline{A}	В	7	20				-SPACE-
-SPACE-				21	\overline{Z}	Α	7	22				-SPACE-
-SPACE-				23	7	В	2	24				-SPACE-
VOLTAGE AMPS	180	180								11520	11520	
200A MCB, 14, 24 SPA	CE, 120	/240V	L1			L2						
MB RATING: 65,000 AIC			1170	0	1	170	0	VOLTAGE AMPS				
			98			98		AMF	S			
				9	8			MAX AMPS				
				12	23			MAX	125%			

PANEL SCHEDULE

 NO SCALE
 2

 NOT USED
 NO SCALE
 3



TYPICAL EQUIPMENT GROUNDING PLAN

ANTENNAS AND OVP SHOWN ARE GENERIC AND NOT

REFERENCING TO A SPECIFIC MANUFACTURER. THIS LAYOUT IS FOR REFERENCE PURPOSES ONLY PROPOSED 4"x6"x1/4" TINNED COPPER SECTOR GROUND BUSS BAR (TYP OF (3)) PROPOSED #2 AWG STRANDED COPPER GREEN INSULATED (TYP) PROPOSED GROUND BUSS BAR INSULATORS -PROPOSED #6 AWG STRANDED COPPER GREEN INSULATED (TYP) -

EXOTHERMIC CONNECTION TEST GROUND ROD WITH INSPECTION SLEEVE MECHANICAL CONNECTION ---- #6 AWG STRANDED & INSULATED GROUND BUS BAR #2 AWG SOLID COPPER TINNED GROUND ROD **BUSS BAR INSULATOR**

GROUNDING LEGEND

1. GROUNDING IS SHOWN DIAGRAMMATICALLY ONLY.

NO SCALE

NO SCALE

NOTES

- 2. CONTRACTOR SHALL GROUND ALL EQUIPMENT AS A COMPLETE SYSTEM. GROUNDING SHALL BE IN COMPLIANCE WITH NEC SECTION 250 AND DISH Wireless L.L.C. GROUNDING AND BONDING REQUIREMENTS AND MANUFACTURER'S SPECIFICATIONS.
- 3. ALL GROUND CONDUCTORS SHALL BE COPPER; NO ALUMINUM CONDUCTORS SHALL BE USED.

GROUNDING KEY NOTES

- EXTERIOR GROUND RING: #2 AWG SOLID COPPER, BURIED AT A DEPTH OF AT LEAST 30 INCHES BELOW EXTERIOR GROUND RING: #2 AWG SOLID COPPER, BURIED AT A DEPTH OF AT LEAST 30 INCHES BELOW GRADE, OR 6 INCHES BELOW THE FROST LINE AND APPROXIMATELY 24 INCHES FROM THE EXTERIOR WALL OR FOOTING.
- TOWER GROUND RING: THE GROUND RING SYSTEM SHALL BE INSTALLED AROUND AN ANTENNA TOWER'S LEGS, AND/OR GUY ANCHORS. WHERE SEPARATE SYSTEMS HAVE BEEN PROVIDED FOR THE TOWER AND THE BUILDING, AT LEAST TWO BONDS SHALL BE MADE BETWEEN THE TOWER RING GROUND SYSTEM AND THE BUILDING RING GROUND SYSTEM USING MINIMUM #2 AWG SOLID COPPER CONDUCTORS.
- INTERIOR GROUND RING: #2 AWG STRANDED GREEN INSULATED COPPER CONDUCTOR EXTENDED AROUND THE PERIMETER OF THE EQUIPMENT AREA. ALL NON-TELECOMMUNICATIONS BELATED METALLIC OR 15070 501111 PERIMETER OF THE EQUIPMENT AREA. ALL NON-TELECOMMUNICATIONS RELATED METALLIC OBJECTS FOUND WITHIN A SITE SHALL BE GROUNDED TO THE INTERIOR GROUND RING WITH #6 AWG STRANDED GREEN INSULATED CONDUCTOR.
- BOND TO INTERIOR GROUND RING: #2 AWG SOLID TINNED COPPER WIRE PRIMARY BONDS SHALL BE PROVIDED AT LEAST AT FOUR POINTS ON THE INTERIOR GROUND RING, LOCATED AT THE CORNERS OF THE
- E GROUND ROD: UL LISTED COPPER CLAD STEEL. MINIMUM 1/2" DIAMETER BY EIGHT FEET LONG. GROUND RODS SHALL BE INSTALLED WITH INSPECTION SLEEVES. GROUND RODS SHALL BE DRIVEN TO THE DEPTH OF GROUND ROD: UL LISTED COPPER CLAD STEEL. MINIMUM 1/2" DIAMETER BY EIGHT FEET LONG. GROUND GROUND RING CONDUCTOR.
- F CELL REFERENCE GROUND BAR: POINT OF GROUND REFERENCE FOR ALL COMMUNICATIONS EQUIPMENT FRAMES. ALL BONDS ARE MADE WITH #2 AWG UNLESS NOTED OTHERWISE STRANDED GREEN INSULATED COPPER CONDUCTORS. BOND TO GROUND RING WITH (2) #2 SOLID TINNED COPPER CONDUCTORS.
- G HATCH PLATE GROUND BAR: BOND TO THE INTERIOR GROUND RING WITH TWO #2 AWG STRANDED GREEN INSULATED COPPER CONDUCTORS. WHEN A HATCH-PLATE AND A CELL REFERENCE GROUND BAR ARE BOTH PRESENT, THE CRGB MUST BE CONNECTED TO THE HATCH-PLATE AND TO THE INTERIOR GROUND RING USING (2) TWO #2 AWG STRANDED GREEN INSULATED COPPER CONDUCTORS EACH.
- EXTERIOR CABLE ENTRY PORT GROUND BARS: LUCATED AT THE ENTRANCE TO THE CELL SITE DOILDING. SO TO GROUND RING WITH A #2 AWG SOLID TINNED COPPER CONDUCTORS WITH AN EXOTHERMIC WELD AND EXTERIOR CABLE ENTRY PORT GROUND BARS: LOCATED AT THE ENTRANCE TO THE CELL SITE BUILDING. BOND INSPECTION SLEEVE.
- TELCO GROUND BAR: BOND TO BOTH CELL REFERENCE GROUND BAR OR EXTERIOR GROUND RING.
- FRAME BONDING: THE BONDING POINT FOR TELECOM EQUIPMENT FRAMES SHALL BE THE GROUND BUS THAT IS NOT ISOLATED FROM THE EQUIPMENTS METAL FRAMEWORK.
- INTERIOR UNIT BONDS: METAL FRAMES, CABINETS AND INDIVIDUAL METALLIC UNITS LOCATED WITH THE AREA
 OF THE INTERIOR GROUND RING REQUIRE A #6 AWG STRANDED GREEN INSULATED COPPER BOND TO THE OF THE INTERIOR GROUND RING REQUIRE A #6 AWG STRANDED GREEN INSULATED COPPER BOND TO THE INTERIOR GROUND RING.
- FENCE AND GATE GROUNDING: METAL FENCES WITHIN 7 FEET OF THE EXTERIOR GROUND RING OR OBJECTS BONDED TO THE EXTERIOR GROUND RING SHALL BE BONDED TO THE GROUND RING WITH A #2 AWG SOLID TINNED COPPER CONDUCTOR AT AN INTERVAL NOT EXCEEDING 25 FEET. BONDS SHALL BE MADE AT EACH GATE POST AND ACROSS GATE OPENINGS.
- EXTERIOR UNIT BONDS: METALLIC OBJECTS, EXTERNAL TO OR MOUNTED TO THE BUILDING, SHALL BE BONDED TO THE EXTERIOR GROUND RING. USING #2 TINNED SOLID COPPER WIRE TO THE EXTERIOR GROUND RING. USING #2 TINNED SOLID COPPER WIRE
- N ICE BRIDGE SUPPORTS: EACH ICE BRIDGE LEG SHALL BE BONDED TO THE GROUND RING WITH #2 AWG BARE TINNED COPPER CONDUCTOR. PROVIDE EXOTHERMIC WELDS AT BOTH THE ICE BRIDGE LEG AND BURIED GROUND RING.
- DURING ALL DC POWER SYSTEM CHANGES INCLUDING DC SYSTEM CHANGE OUTS, RECTIFIER REPLACEMENTS OR ADDITIONS, BREAKER DISTRIBUTION CHANGES, BATTERY ADDITIONS, BATTERY REPLACEMENTS AND INSTALLATIONS OR CHANGES TO DC CONVERTER SYSTEMS IT SHALL BE REQUIRED THAT SERVICE CONTRACTORS VERIFY ALL DC POWER SYSTEMS ARE EQUIPPED WITH A MASTER DC SYSTEM RETURN GROUND CONDUCTOR FROM THE DC POWER SYSTEM COMMON RETURN BUS DIRECTLY CONNECTED TO THE CELL SITE REFERENCE GROUND BAR
- (P) TOWER TOP COLLECTOR BUSS BAR IS TO BE MECHANICALLY BONDED TO TOWER STEEL.

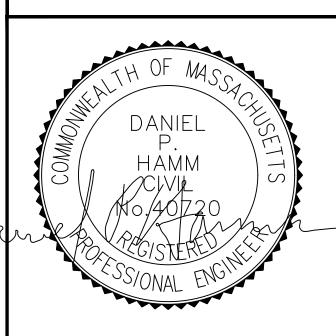
REFER TO DISH Wireless L.L.C. GROUNDING NOTES.



5701 SOUTH SANTA FE DRIVE LITTLETON, CO 80120



45 BEECHWOOD DRIVE TEL: (978) 557-5553 N. ANDOVER, MA 01845 FAX: (978) 336-5586



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DRAWN	BY:	CHECKED	BY:	APPROVED	BY:
PS		SMA		DPH	

RFDS REV #:

PRELIMINARY **DOCUMENTS**

	SUBMITTALS						
REV	DATE DESCRIPTION						
A	11/15/2021 ISSUED FOR REVIEW						
В	01/21/2022	ISSUED FOR REVIEW					
A&E PROJECT NUMBER							

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DISH Wireless L.L.C. PROJECT INFORMATION BOBOSO0592A CROWN CASTLE BU#841273

344 ROUTE 6 NORTH TRURO, MA 02652

> SHEET TITLE GROUNDING PLANS

> > AND NOTES

SHEET NUMBER

G-1

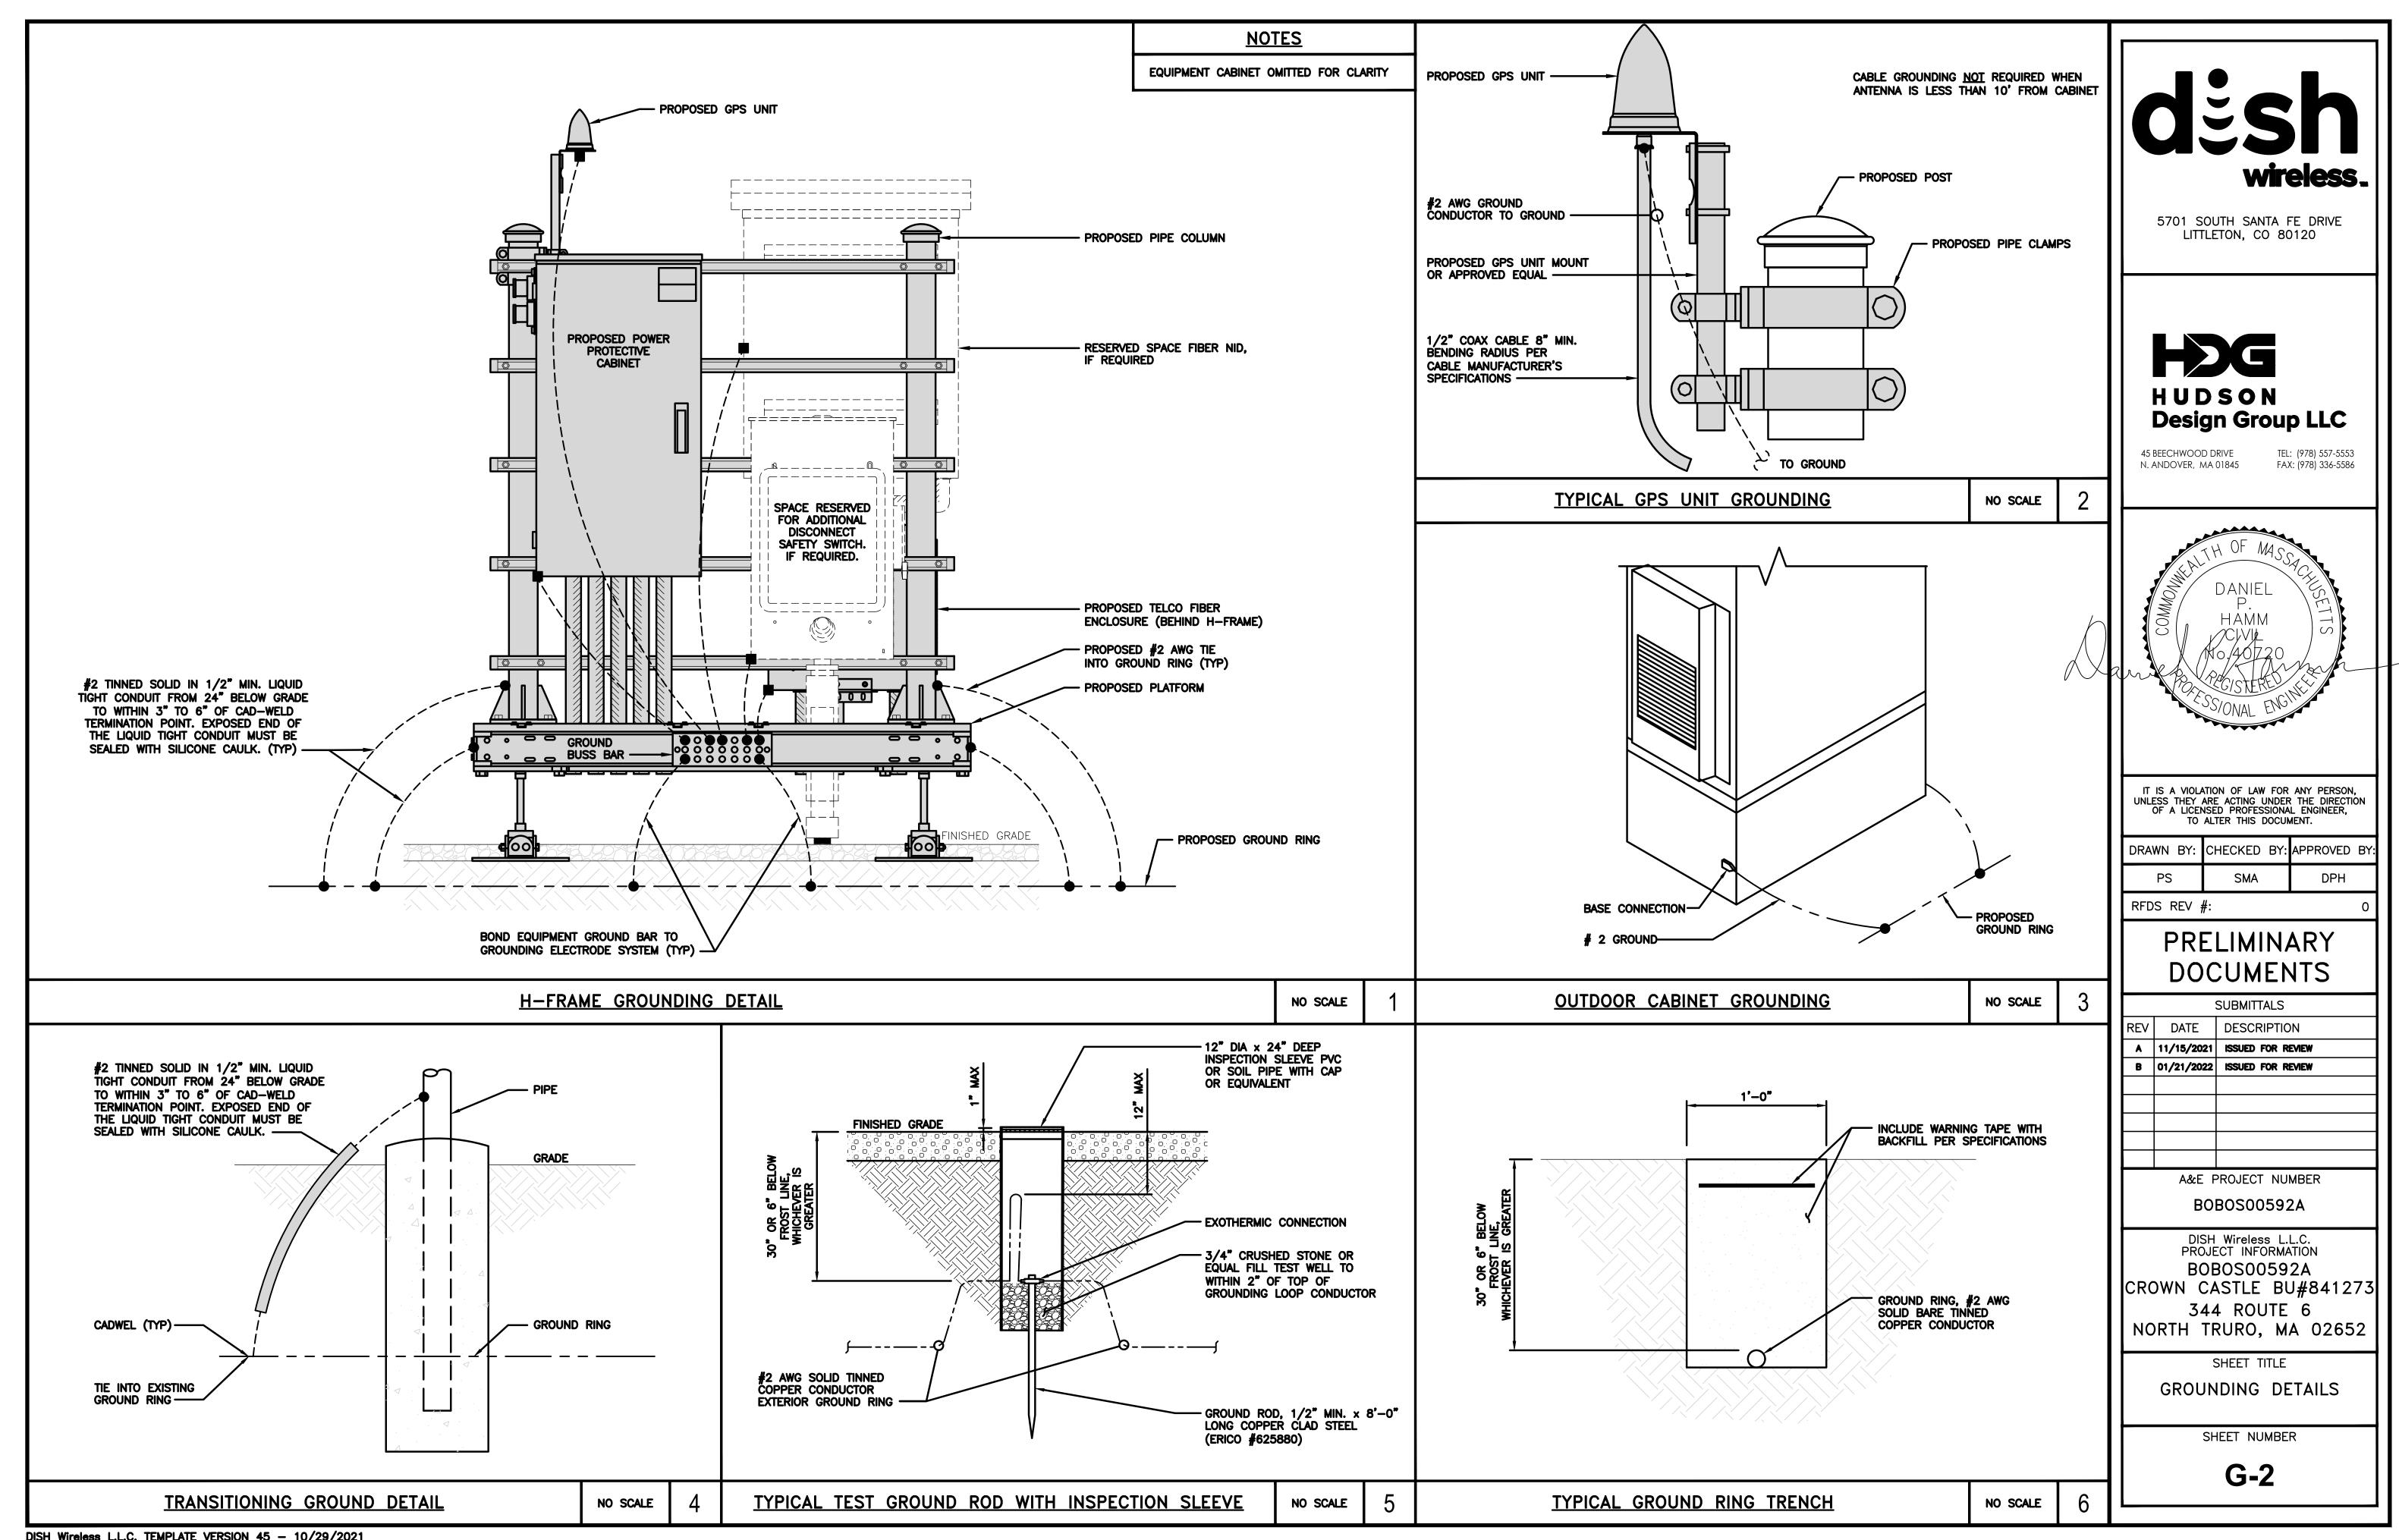
GROUNDING KEY NOTES

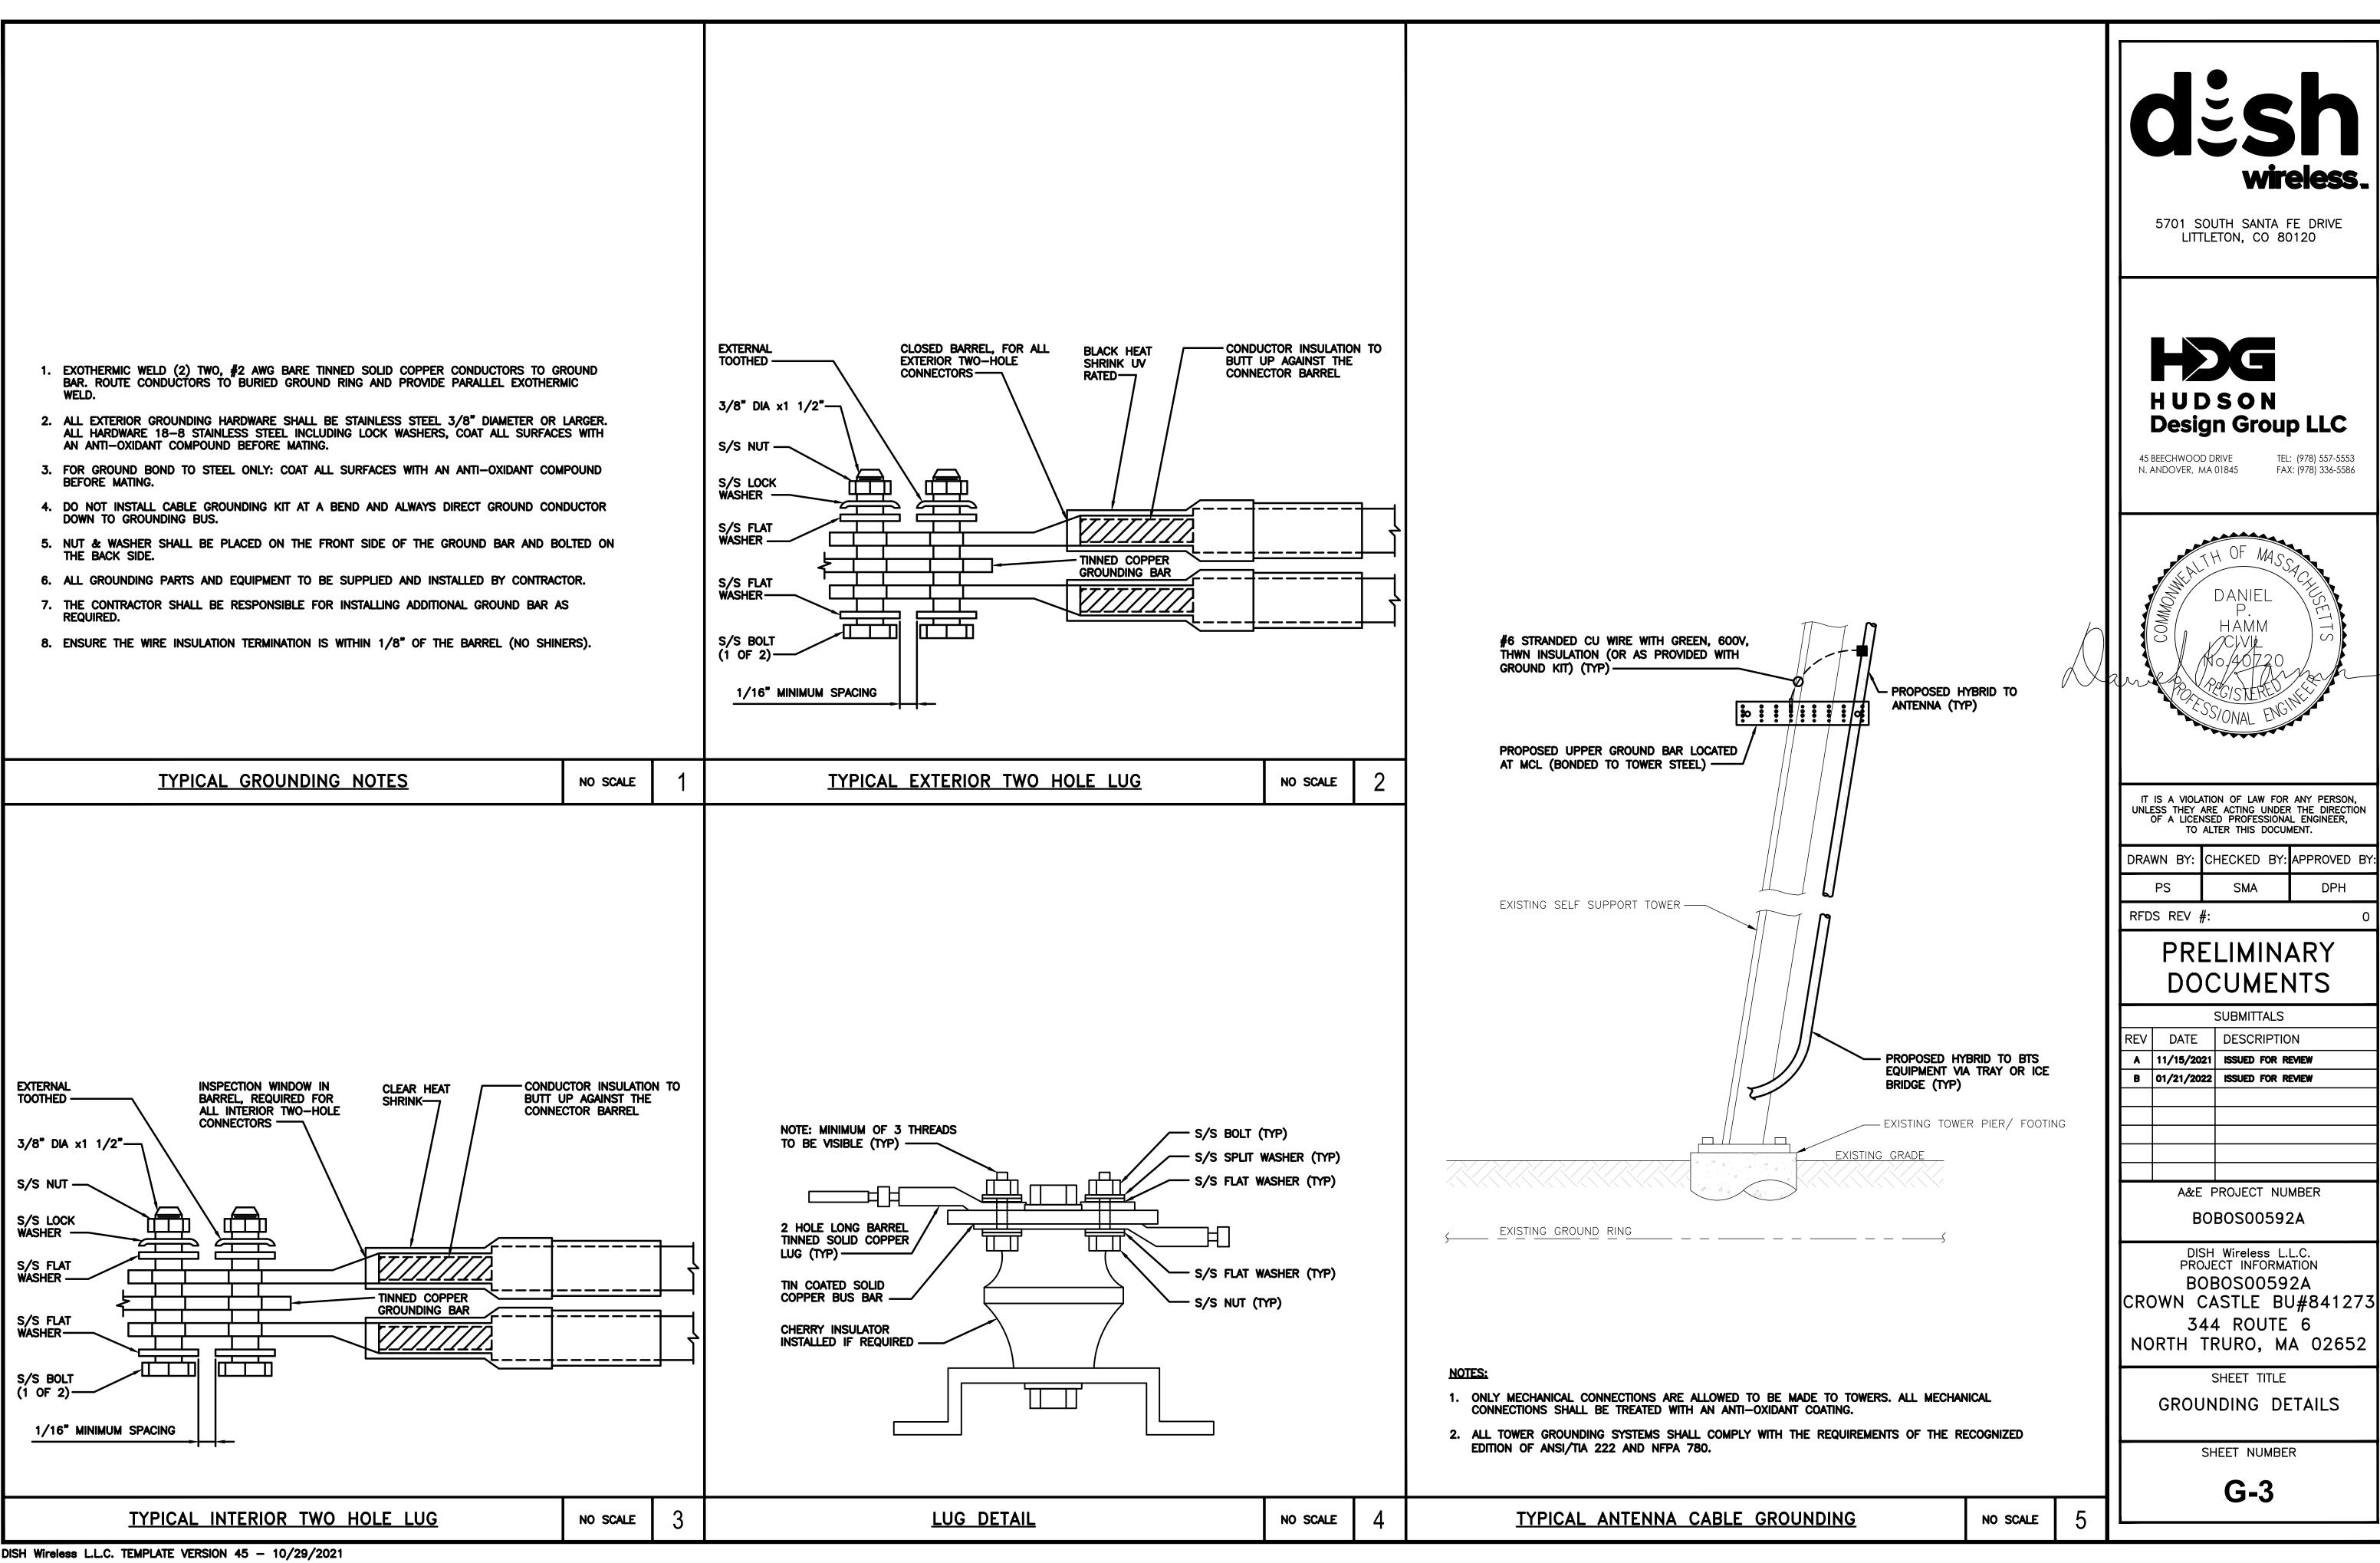
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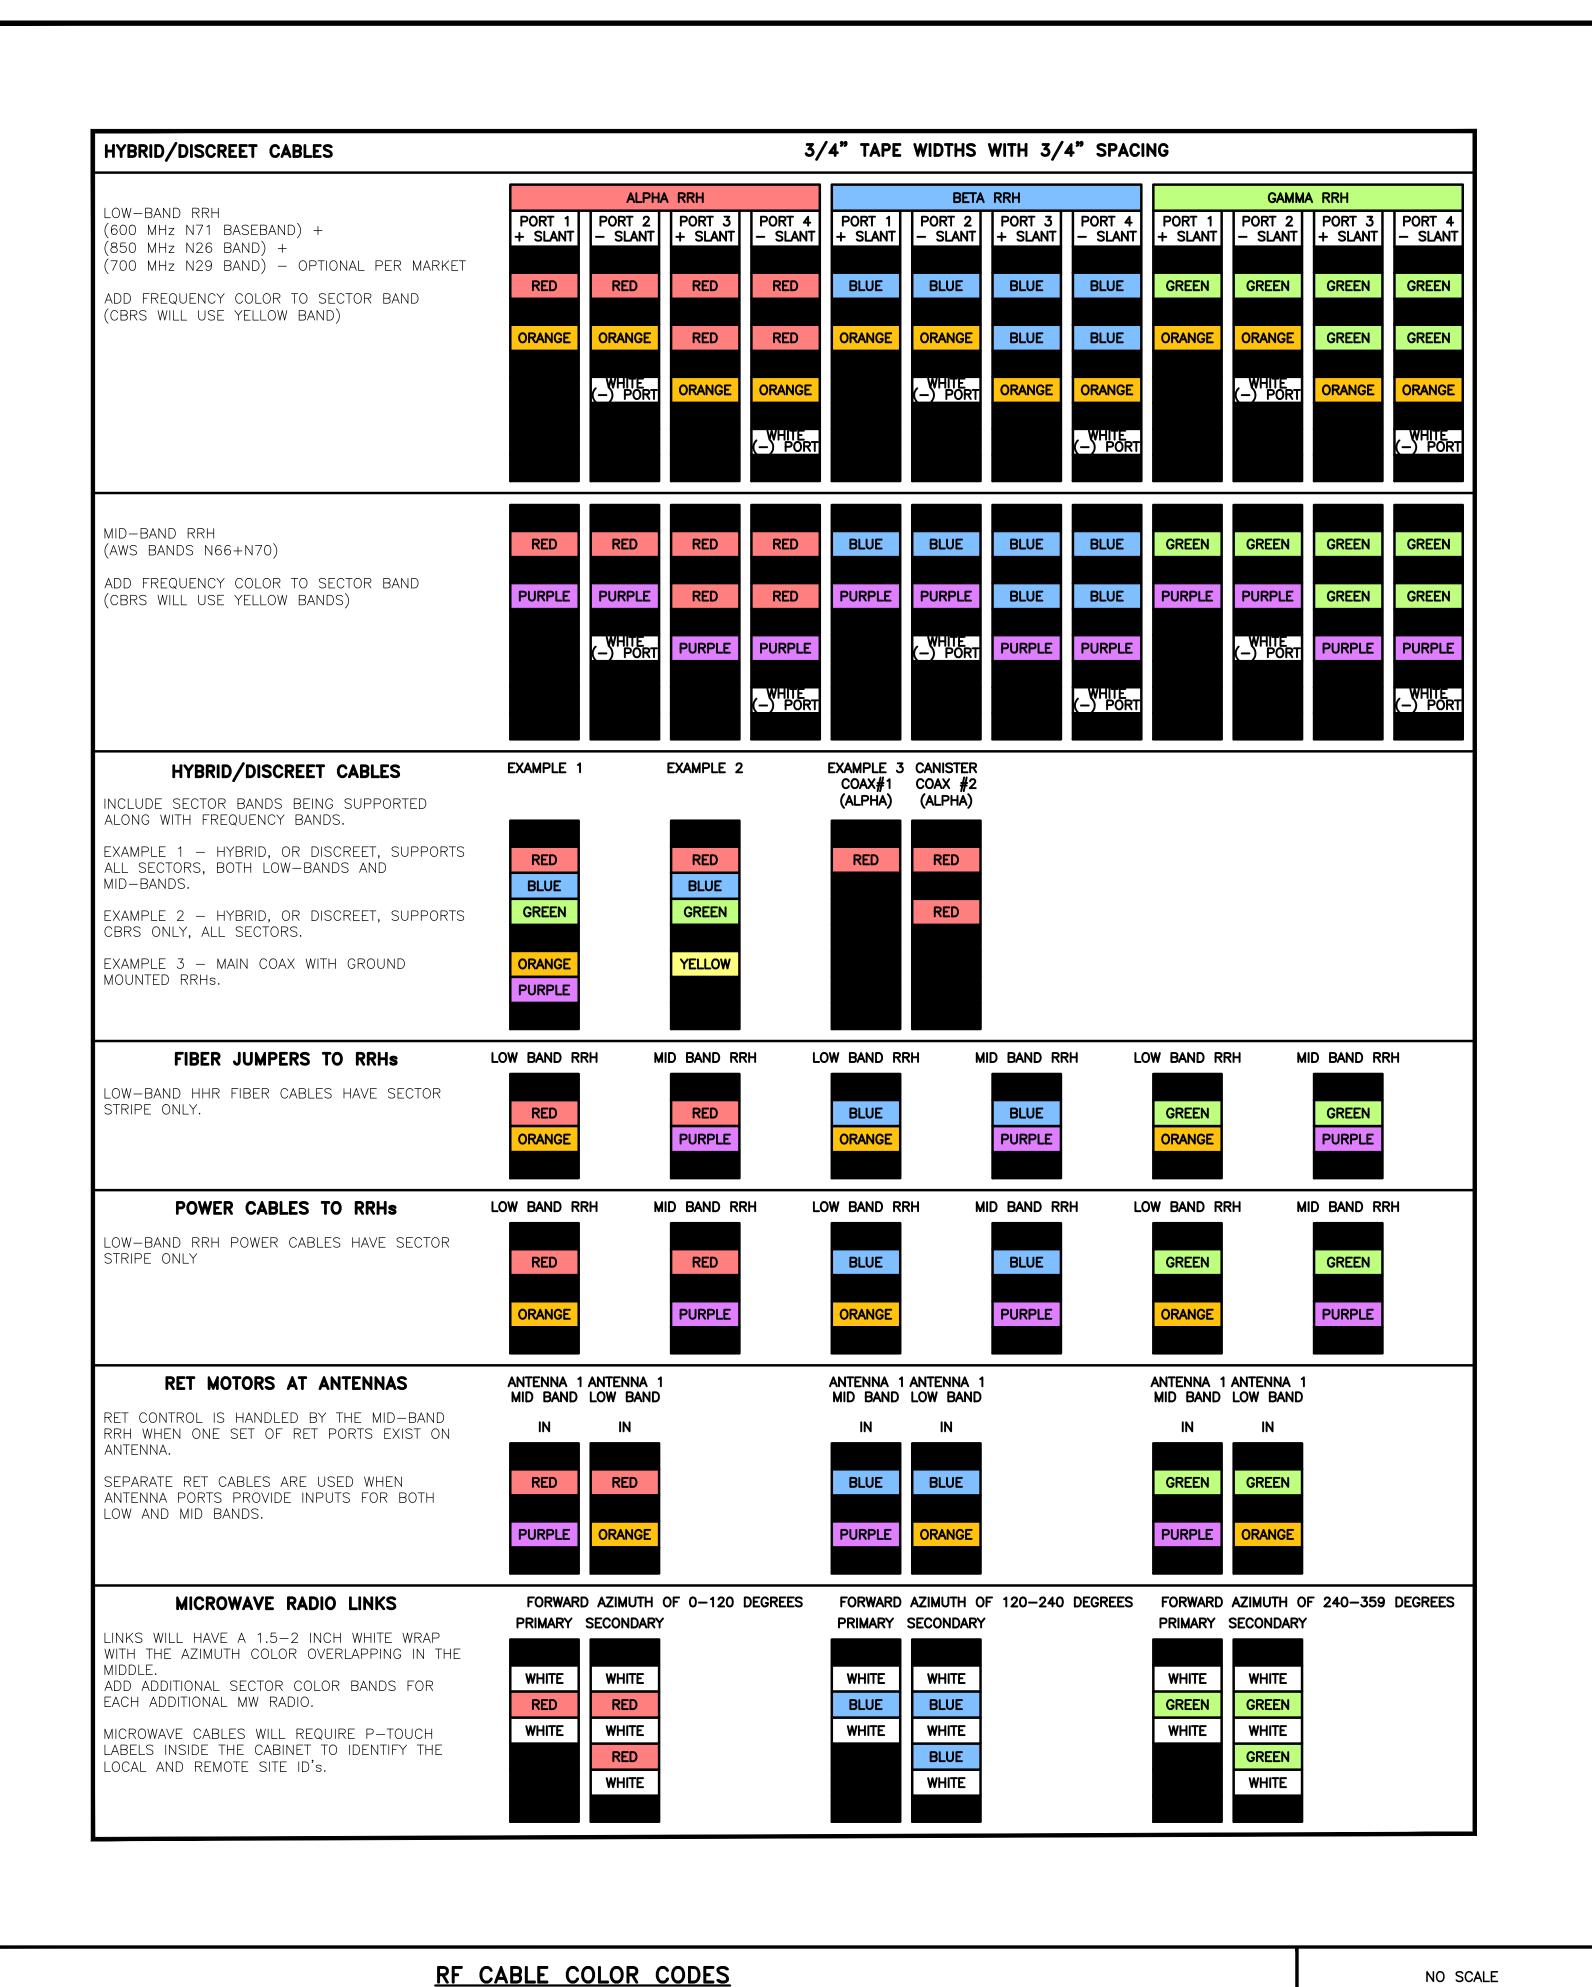
DISH Wireless L.L.C. TEMPLATE VERSION 45 - 10/29/2021


PROPOSED UPPER TOWER GROUND BUSS BAR -

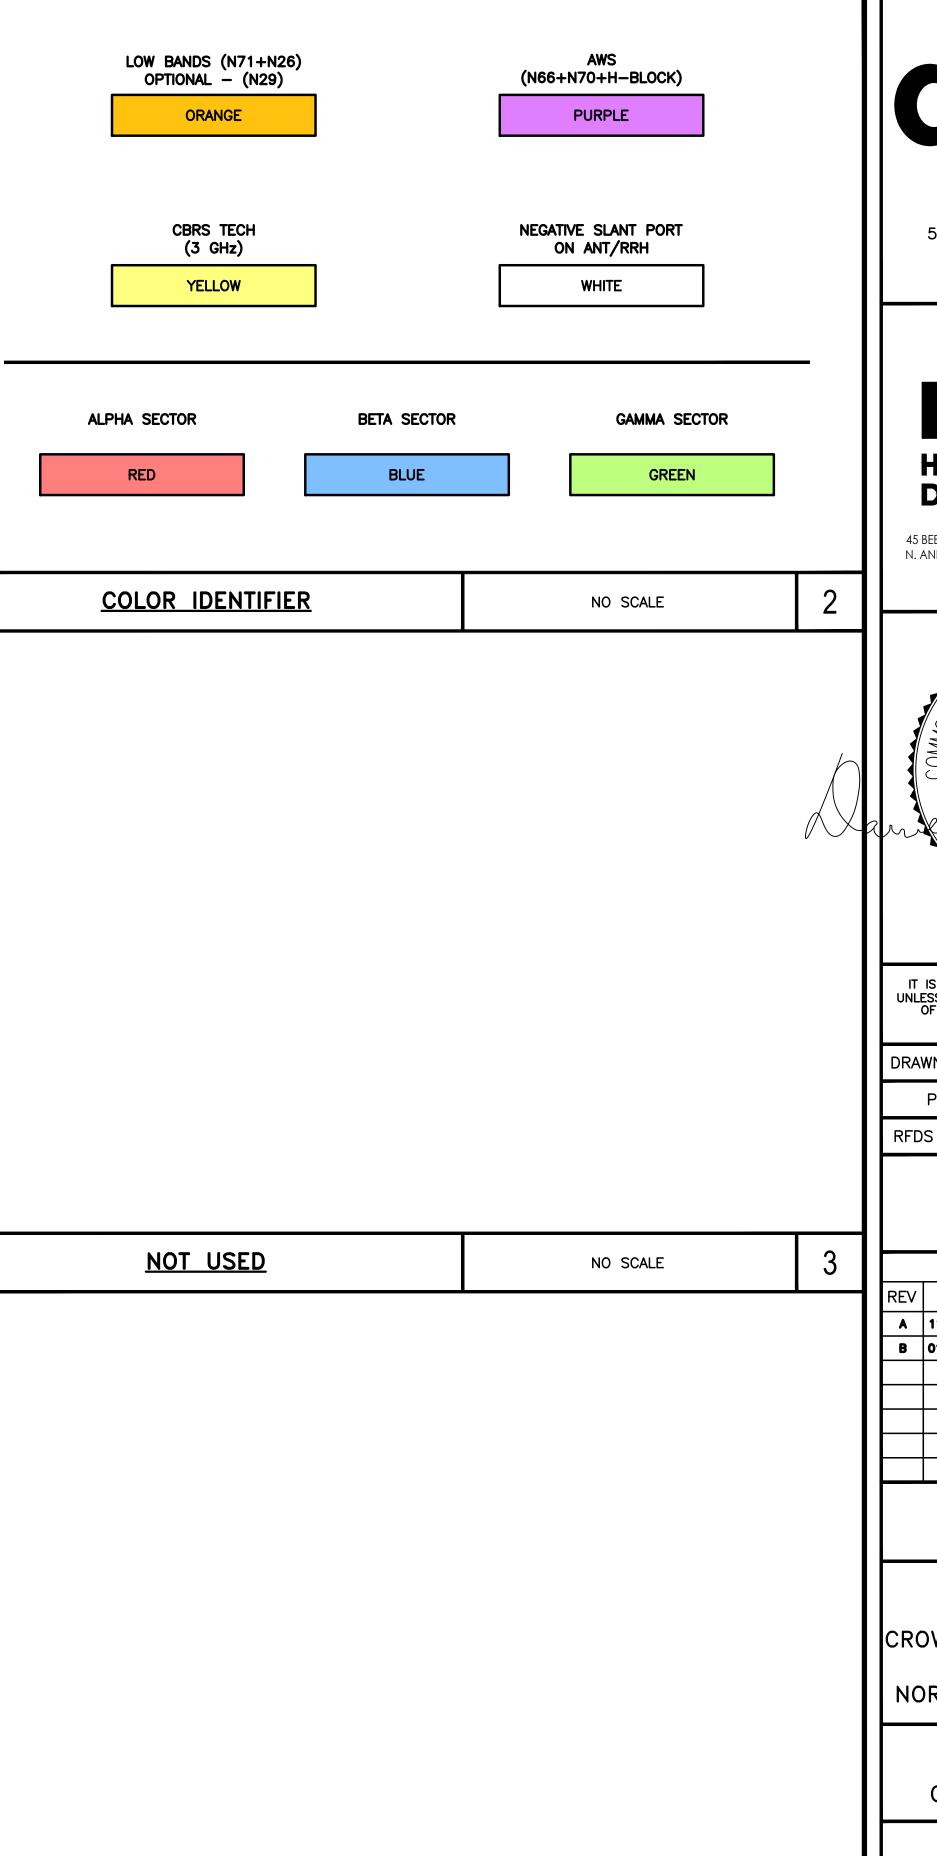TYPICAL ANTENNA GROUNDING PLAN









NO SCALE

NOT USED

dish wireless.

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DISH Wireless L.L.C.
PROJECT INFORMATION
BOBOS00592A
CROWN CASTLE BU#841273

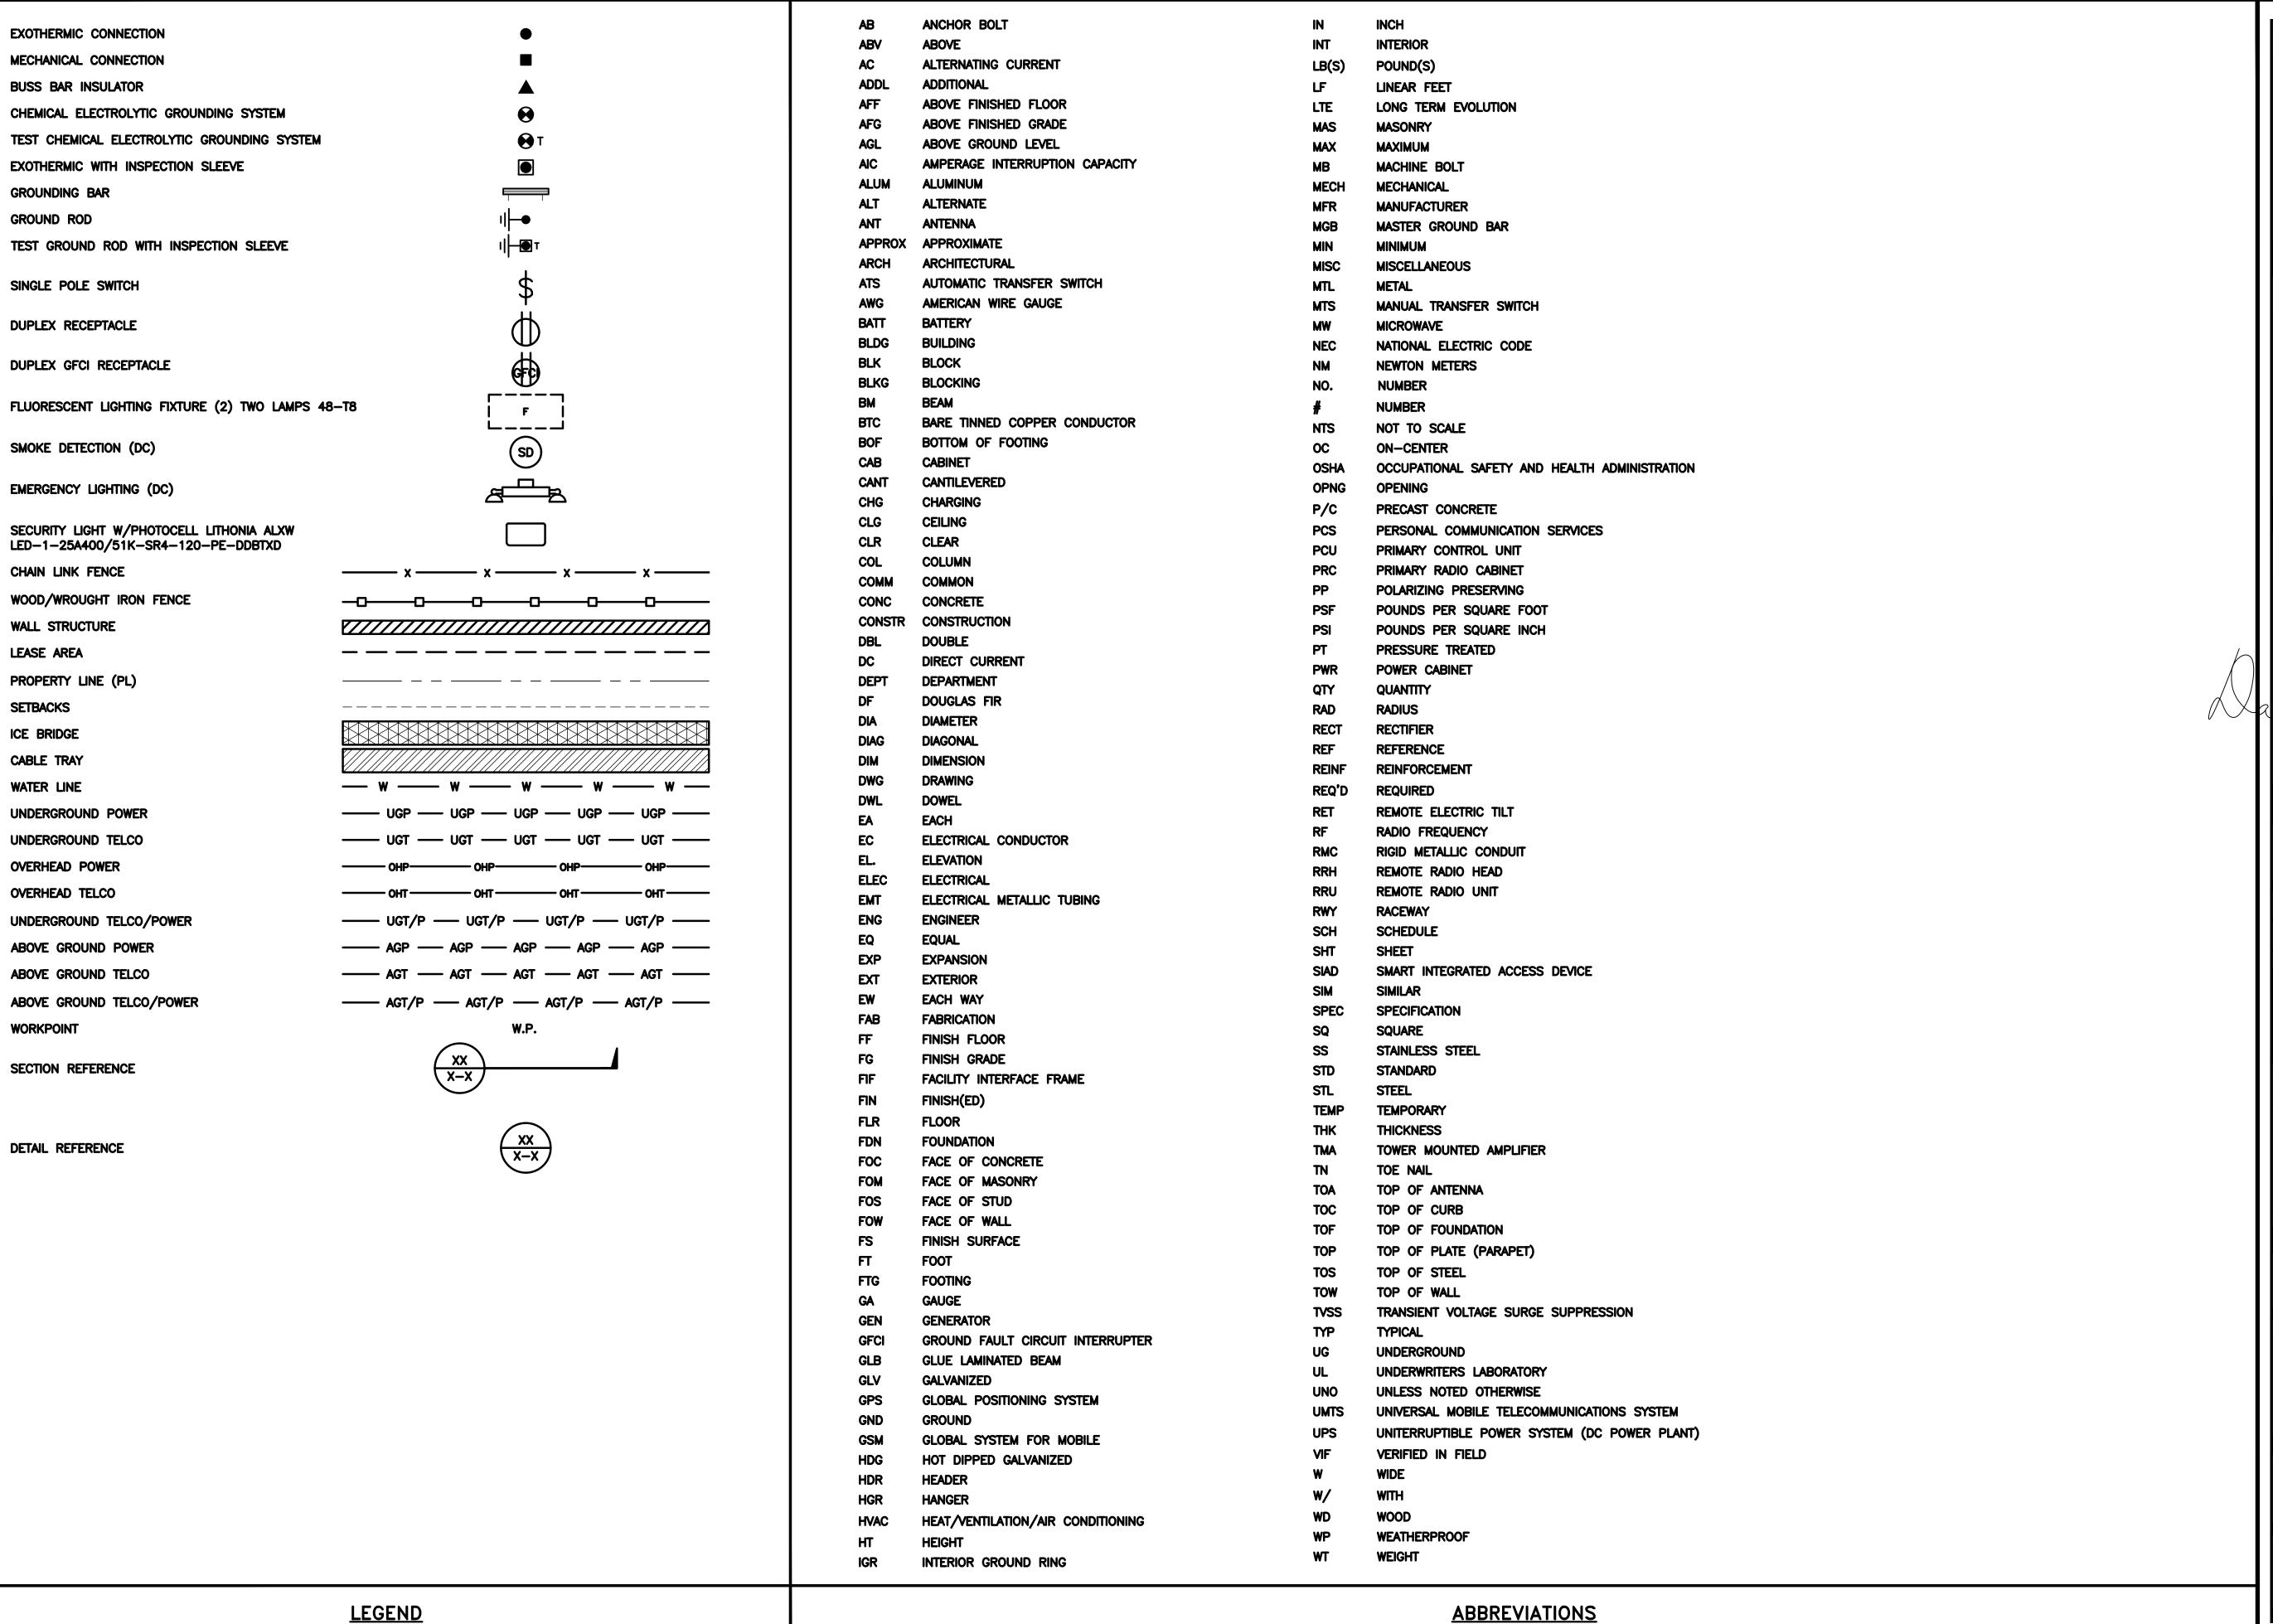
344 ROUTE 6 NORTH TRURO, MA 02652

SHEET TITLE

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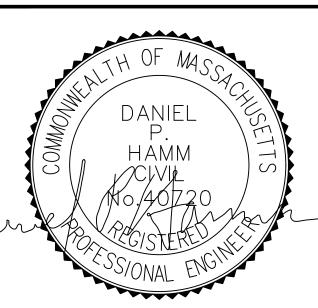




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DISH Wireless L.L.C.
PROJECT INFORMATION
BOBOS00592A
CROWN CASTLE BU#841273
344 ROUTE 6

NORTH TRURO, MA 02652

SHEET TITLE

LEGEND AND ABBREVIATIONS

SHEET NUMBER

SITE ACTIVITY REQUIREMENTS:

- 1. NOTICE TO PROCEED NO WORK SHALL COMMENCE PRIOR TO CONTRACTOR RECEIVING A WRITTEN NOTICE TO PROCEED (NTP) AND THE ISSUANCE OF A PURCHASE ORDER. PRIOR TO ACCESSING/ENTERING THE SITE YOU MUST CONTACT THE DISH Wireless L.L.C. AND TOWER OWNER NOC & THE DISH Wireless L.L.C. AND TOWER CONSTRUCTION MANAGER.
- 2. "LOOK UP" DISH Wireless L.L.C. AND TOWER OWNER SAFETY CLIMB REQUIREMENT:

THE INTEGRITY OF THE SAFETY CLIMB AND ALL COMPONENTS OF THE CLIMBING FACILITY SHALL BE CONSIDERED DURING ALL STAGES OF DESIGN, INSTALLATION, AND INSPECTION. TOWER MODIFICATION, MOUNT REINFORCEMENTS, AND/OR EQUIPMENT INSTALLATIONS SHALL NOT COMPROMISE THE INTEGRITY OR FUNCTIONAL USE OF THE SAFETY CLIMB OR ANY COMPONENTS OF THE CLIMBING FACILITY ON THE STRUCTURE. THIS SHALL INCLUDE, BUT NOT BE LIMITED TO: PINCHING OF THE WIRE ROPE, BENDING OF THE WIRE ROPE FROM ITS SUPPORTS, DIRECT CONTACT OR CLOSE PROXIMITY TO THE WIRE ROPE WHICH MAY CAUSE FRICTIONAL WEAR, IMPACT TO THE ANCHORAGE POINTS IN ANY WAY, OR TO IMPEDE/BLOCK ITS INTENDED USE. ANY COMPROMISED SAFETY CLIMB, INCLUDING EXISTING CONDITIONS MUST BE TAGGED OUT AND REPORTED TO YOUR DISH Wireless L.L.C. AND DISH Wireless L.L.C. AND TOWER OWNER POC OR CALL THE NOC TO GENERATE A SAFETY CLIMB MAINTENANCE AND CONTRACTOR NOTICE TICKET.

- 3. PRIOR TO THE START OF CONSTRUCTION, ALL REQUIRED JURISDICTIONAL PERMITS SHALL BE OBTAINED. THIS INCLUDES, BUT IS NOT LIMITED TO, BUILDING, ELECTRICAL, MECHANICAL, FIRE, FLOOD ZONE, ENVIRONMENTAL, AND ZONING. AFTER ONSITE ACTIVITIES AND CONSTRUCTION ARE COMPLETED, ALL REQUIRED PERMITS SHALL BE SATISFIED AND CLOSED OUT ACCORDING TO LOCAL JURISDICTIONAL REQUIREMENTS.
- 4. ALL CONSTRUCTION MEANS AND METHODS; INCLUDING BUT NOT LIMITED TO, ERECTION PLANS, RIGGING PLANS, CLIMBING PLANS, AND RESCUE PLANS SHALL BE THE RESPONSIBILITY OF THE GENERAL CONTRACTOR RESPONSIBLE FOR THE EXECUTION OF THE WORK CONTAINED HEREIN, AND SHALL MEET ANSI/ASSE A10.48 (LATEST EDITION); FEDERAL, STATE, AND LOCAL REGULATIONS; AND ANY APPLICABLE INDUSTRY CONSENSUS STANDARDS RELATED TO THE CONSTRUCTION ACTIVITIES BEING PERFORMED. ALL RIGGING PLANS SHALL ADHERE TO ANSI/ASSE A10.48 (LATEST EDITION) AND DISH Wireless L.L.C. AND TOWER OWNER STANDARDS, INCLUDING THE REQUIRED INVOLVEMENT OF A QUALIFIED ENGINEER FOR CLASS IV CONSTRUCTION, TO CERTIFY THE SUPPORTING STRUCTURE(S) IN ACCORDANCE WITH ANSI/TIA—322 (LATEST EDITION).
- 5. ALL SITE WORK TO COMPLY WITH DISH Wireless L.L.C. AND TOWER OWNER INSTALLATION STANDARDS FOR CONSTRUCTION ACTIVITIES ON DISH Wireless L.L.C. AND TOWER OWNER TOWER SITE AND LATEST VERSION OF ANSI/TIA-1019-A-2012 "STANDARD FOR INSTALLATION, ALTERATION, AND MAINTENANCE OF ANTENNA SUPPORTING STRUCTURES AND ANTENNAS."
- 6. IF THE SPECIFIED EQUIPMENT CAN NOT BE INSTALLED AS SHOWN ON THESE DRAWINGS, THE CONTRACTOR SHALL PROPOSE AN ALTERNATIVE INSTALLATION FOR APPROVAL BY DISH Wireless L.L.C. AND TOWER OWNER PRIOR TO PROCEEDING WITH ANY SUCH CHANGE OF INSTALLATION.
- 7. ALL MATERIALS FURNISHED AND INSTALLED SHALL BE IN STRICT ACCORDANCE WITH ALL APPLICABLE CODES, REGULATIONS AND ORDINANCES. CONTRACTOR SHALL ISSUE ALL APPROPRIATE NOTICES AND COMPLY WITH ALL LAWS, ORDINANCES, RULES, REGULATIONS AND LAWFUL ORDERS OF ANY PUBLIC AUTHORITY REGARDING THE PERFORMANCE OF THE WORK. ALL WORK CARRIED OUT SHALL COMPLY WITH ALL APPLICABLE MUNICIPAL AND UTILITY COMPANY SPECIFICATIONS AND LOCAL JURISDICTIONAL CODES, ORDINANCES AND APPLICABLE REGULATIONS.
- 8. THE CONTRACTOR SHALL INSTALL ALL EQUIPMENT AND MATERIALS IN ACCORDANCE WITH MANUFACTURER'S RECOMMENDATIONS UNLESS SPECIFICALLY STATED OTHERWISE.
- 9. THE CONTRACTOR SHALL CONTACT UTILITY LOCATING SERVICES INCLUDING PRIVATE LOCATES SERVICES PRIOR TO THE START OF CONSTRUCTION.
- 10. ALL EXISTING ACTIVE SEWER, WATER, GAS, ELECTRIC AND OTHER UTILITIES WHERE ENCOUNTERED IN THE WORK, SHALL BE PROTECTED AT ALL TIMES AND WHERE REQUIRED FOR THE PROPER EXECUTION OF THE WORK, SHALL BE RELOCATED AS DIRECTED BY CONTRACTOR. EXTREME CAUTION SHOULD BE USED BY THE CONTRACTOR WHEN EXCAVATING OR DRILLING PIERS AROUND OR NEAR UTILITIES. CONTRACTOR SHALL PROVIDE SAFETY TRAINING FOR THE WORKING CREW. THIS WILL INCLUDE BUT NOT BE LIMITED TO A) FALL PROTECTION B) CONFINED SPACE C) ELECTRICAL SAFETY D) TRENCHING AND EXCAVATION E) CONSTRUCTION SAFETY PROCEDURES.
- 11. ALL SITE WORK SHALL BE AS INDICATED ON THE STAMPED CONSTRUCTION DRAWINGS AND DISH PROJECT SPECIFICATIONS, LATEST APPROVED REVISION.
- 12. CONTRACTOR SHALL KEEP THE SITE FREE FROM ACCUMULATING WASTE MATERIAL, DEBRIS, AND TRASH AT THE COMPLETION OF THE WORK. IF NECESSARY, RUBBISH, STUMPS, DEBRIS, STICKS, STONES AND OTHER REFUSE SHALL BE REMOVED FROM THE SITE AND DISPOSED OF LEGALLY.
- 13. ALL EXISTING INACTIVE SEWER, WATER, GAS, ELECTRIC AND OTHER UTILITIES, WHICH INTERFERE WITH THE EXECUTION OF THE WORK, SHALL BE REMOVED AND/OR CAPPED, PLUGGED OR OTHERWISE DISCONTINUED AT POINTS WHICH WILL NOT INTERFERE WITH THE EXECUTION OF THE WORK, SUBJECT TO THE APPROVAL OF DISH Wireless L.L.C. AND TOWER OWNER, AND/OR LOCAL UTILITIES.
- 14. THE CONTRACTOR SHALL PROVIDE SITE SIGNAGE IN ACCORDANCE WITH THE TECHNICAL SPECIFICATION FOR SITE SIGNAGE REQUIRED BY LOCAL JURISDICTION AND SIGNAGE REQUIRED ON INDIVIDUAL PIECES OF EQUIPMENT, ROOMS, AND SHELTERS.
- 15. THE SITE SHALL BE GRADED TO CAUSE SURFACE WATER TO FLOW AWAY FROM THE CARRIER'S EQUIPMENT AND TOWER AREAS.
- 16. THE SUB GRADE SHALL BE COMPACTED AND BROUGHT TO A SMOOTH UNIFORM GRADE PRIOR TO FINISHED SURFACE APPLICATION.
- 17. THE AREAS OF THE OWNERS PROPERTY DISTURBED BY THE WORK AND NOT COVERED BY THE TOWER, EQUIPMENT OR DRIVEWAY, SHALL BE GRADED TO A UNIFORM SLOPE, AND STABILIZED TO PREVENT EROSION AS SPECIFIED ON THE CONSTRUCTION DRAWINGS AND/OR PROJECT SPECIFICATIONS.
- 18. CONTRACTOR SHALL MINIMIZE DISTURBANCE TO EXISTING SITE DURING CONSTRUCTION. EROSION CONTROL MEASURES, IF REQUIRED DURING CONSTRUCTION, SHALL BE IN CONFORMANCE WITH THE LOCAL GUIDELINES FOR EROSION AND SEDIMENT CONTROL.
- 19. THE CONTRACTOR SHALL PROTECT EXISTING IMPROVEMENTS, PAVEMENTS, CURBS, LANDSCAPING AND STRUCTURES. ANY DAMAGED PART SHALL BE REPAIRED AT CONTRACTOR'S EXPENSE TO THE SATISFACTION OF OWNER.
- 20. CONTRACTOR SHALL LEGALLY AND PROPERLY DISPOSE OF ALL SCRAP MATERIALS SUCH AS COAXIAL CABLES AND OTHER ITEMS REMOVED FROM THE EXISTING FACILITY. ANTENNAS AND RADIOS REMOVED SHALL BE RETURNED TO THE OWNER'S DESIGNATED LOCATION.
- 21. CONTRACTOR SHALL LEAVE PREMISES IN CLEAN CONDITION. TRASH AND DEBRIS SHOULD BE REMOVED FROM SITE ON A DAILY BASIS.
- 22. NO FILL OR EMBANKMENT MATERIAL SHALL BE PLACED ON FROZEN GROUND. FROZEN MATERIALS, SNOW OR ICE SHALL NOT BE PLACED IN ANY FILL OR EMBANKMENT.

GENERAL NOTES:

1.FOR THE PURPOSE OF CONSTRUCTION DRAWING, THE FOLLOWING DEFINITIONS SHALL APPLY:

CONTRACTOR: GENERAL CONTRACTOR RESPONSIBLE FOR CONSTRUCTION

CARRIER:DISH Wireless L.L.C.

TOWER OWNER:TOWER OWNER


- 2. THESE DRAWINGS HAVE BEEN PREPARED USING STANDARDS OF PROFESSIONAL CARE AND COMPLETENESS NORMALLY EXERCISED UNDER SIMILAR CIRCUMSTANCES BY REPUTABLE ENGINEERS IN THIS OR SIMILAR LOCALITIES. IT IS ASSUMED THAT THE WORK DEPICTED WILL BE PERFORMED BY AN EXPERIENCED CONTRACTOR AND/OR WORKPEOPLE WHO HAVE A WORKING KNOWLEDGE OF THE APPLICABLE CODE STANDARDS AND REQUIREMENTS AND OF INDUSTRY ACCEPTED STANDARD GOOD PRACTICE. AS NOT EVERY CONDITION OR ELEMENT IS (OR CAN BE) EXPLICITLY SHOWN ON THESE DRAWINGS, THE CONTRACTOR SHALL USE INDUSTRY ACCEPTED STANDARD GOOD PRACTICE FOR MISCELLANEOUS WORK NOT EXPLICITLY SHOWN.
- 3. THESE DRAWINGS REPRESENT THE FINISHED STRUCTURE. THEY DO NOT INDICATE THE MEANS OR METHODS OF CONSTRUCTION. THE CONTRACTOR SHALL BE SOLELY RESPONSIBLE FOR THE CONSTRUCTION MEANS, METHODS, TECHNIQUES, SEQUENCES, AND PROCEDURES. THE CONTRACTOR SHALL PROVIDE ALL MEASURES NECESSARY FOR PROTECTION OF LIFE AND PROPERTY DURING CONSTRUCTION. SUCH MEASURES SHALL INCLUDE, BUT NOT BE LIMITED TO, BRACING, FORMWORK, SHORING, ETC. SITE VISITS BY THE ENGINEER OR HIS REPRESENTATIVE WILL NOT INCLUDE INSPECTION OF THESE ITEMS AND IS FOR STRUCTURAL OBSERVATION OF THE FINISHED STRUCTURE ONLY.
- 4. NOTES AND DETAILS IN THE CONSTRUCTION DRAWINGS SHALL TAKE PRECEDENCE OVER GENERAL NOTES AND TYPICAL DETAILS. WHERE NO DETAILS ARE SHOWN, CONSTRUCTION SHALL CONFORM TO SIMILAR WORK ON THE PROJECT, AND/OR AS PROVIDED FOR IN THE CONTRACT DOCUMENTS. WHERE DISCREPANCIES OCCUR BETWEEN PLANS, DETAILS, GENERAL NOTES, AND SPECIFICATIONS, THE GREATER, MORE STRICT REQUIREMENTS, SHALL GOVERN. IF FURTHER CLARIFICATION IS REQUIRED CONTACT THE ENGINEER OF RECORD.
- 5. SUBSTANTIAL EFFORT HAS BEEN MADE TO PROVIDE ACCURATE DIMENSIONS AND MEASUREMENTS ON THE DRAWINGS TO ASSIST IN THE FABRICATION AND/OR PLACEMENT OF CONSTRUCTION ELEMENTS BUT IT IS THE SOLE RESPONSIBILITY OF THE CONTRACTOR TO FIELD VERIFY THE DIMENSIONS, MEASUREMENTS, AND/OR CLEARANCES SHOWN IN THE CONSTRUCTION DRAWINGS PRIOR TO FABRICATION OR CUTTING OF ANY NEW OR EXISTING CONSTRUCTION ELEMENTS. IF IT IS DETERMINED THAT THERE ARE DISCREPANCIES AND/OR CONFLICTS WITH THE CONSTRUCTION DRAWINGS THE ENGINEER OF RECORD IS TO BE NOTIFIED AS SOON AS POSSIBLE.
- 6. PRIOR TO THE SUBMISSION OF BIDS, THE BIDDING CONTRACTOR SHALL VISIT THE CELL SITE TO FAMILIARIZE WITH THE EXISTING CONDITIONS AND TO CONFIRM THAT THE WORK CAN BE ACCOMPLISHED AS SHOWN ON THE CONSTRUCTION DRAWINGS. ANY DISCREPANCY FOUND SHALL BE BROUGHT TO THE ATTENTION OF CARRIER POC AND TOWER OWNER.
- 7. ALL MATERIALS FURNISHED AND INSTALLED SHALL BE IN STRICT ACCORDANCE WITH ALL APPLICABLE CODES, REGULATIONS AND ORDINANCES. CONTRACTOR SHALL ISSUE ALL APPROPRIATE NOTICES AND COMPLY WITH ALL LAWS, ORDINANCES, RULES, REGULATIONS AND LAWFUL ORDERS OF ANY PUBLIC AUTHORITY REGARDING THE PERFORMANCE OF THE WORK. ALL WORK CARRIED OUT SHALL COMPLY WITH ALL APPLICABLE MUNICIPAL AND UTILITY COMPANY SPECIFICATIONS AND LOCAL JURISDICTIONAL CODES, ORDINANCES AND APPLICABLE REGULATIONS.
- 8. UNLESS NOTED OTHERWISE, THE WORK SHALL INCLUDE FURNISHING MATERIALS, EQUIPMENT, APPURTENANCES AND LABOR NECESSARY TO COMPLETE ALL INSTALLATIONS AS INDICATED ON THE DRAWINGS.
- 9. THE CONTRACTOR SHALL INSTALL ALL EQUIPMENT AND MATERIALS IN ACCORDANCE WITH MANUFACTURER'S RECOMMENDATIONS UNLESS SPECIFICALLY STATED OTHERWISE.
- 10. IF THE SPECIFIED EQUIPMENT CAN NOT BE INSTALLED AS SHOWN ON THESE DRAWINGS, THE CONTRACTOR SHALL PROPOSE AN ALTERNATIVE INSTALLATION FOR APPROVAL BY THE CARRIER AND TOWER OWNER PRIOR TO PROCEEDING WITH ANY SUCH CHANGE OF INSTALLATION.
- 11. CONTRACTOR IS TO PERFORM A SITE INVESTIGATION, BEFORE SUBMITTING BIDS, TO DETERMINE THE BEST ROUTING OF ALL CONDUITS FOR POWER, AND TELCO AND FOR GROUNDING CABLES AS SHOWN IN THE POWER, TELCO, AND GROUNDING PLAN DRAWINGS.
- 12. THE CONTRACTOR SHALL PROTECT EXISTING IMPROVEMENTS, PAVEMENTS, CURBS, LANDSCAPING AND STRUCTURES. ANY DAMAGED PART SHALL BE REPAIRED AT CONTRACTOR'S EXPENSE TO THE SATISFACTION OF DISH Wireless L.L.C. AND TOWER OWNER
- 13. CONTRACTOR SHALL LEGALLY AND PROPERLY DISPOSE OF ALL SCRAP MATERIALS SUCH AS COAXIAL CABLES AND OTHER ITEMS REMOVED FROM THE EXISTING FACILITY. ANTENNAS REMOVED SHALL BE RETURNED TO THE OWNER'S DESIGNATED LOCATION.
- 14. CONTRACTOR SHALL LEAVE PREMISES IN CLEAN CONDITION. TRASH AND DEBRIS SHOULD BE REMOVED FROM SITE ON A DAILY BASIS.



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BOBOS00592A

DISH Wireless L.L.C. PROJECT INFORMATION

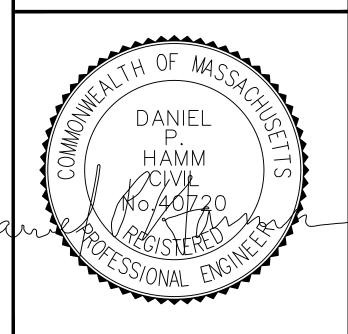BOBOSO0592A CROWN CASTLE BU#841273 344 ROUTE 6 NORTH TRURO, MA 02652

SHEET TITLE

GENERAL NOTES

SHEET NUMBER

CONCRETE, FOUNDATIONS, AND REINFORCING STEEL:

- 1. ALL CONCRETE WORK SHALL BE IN ACCORDANCE WITH THE ACI 301, ACI 318, ACI 336, ASTM A184, ASTM A185 AND THE DESIGN AND CONSTRUCTION SPECIFICATION FOR CAST—IN—PLACE CONCRETE.
- 2. UNLESS NOTED OTHERWISE, SOIL BEARING PRESSURE USED FOR DESIGN OF SLABS AND FOUNDATIONS IS ASSUMED TO BE 1000 psf.
- 3. ALL CONCRETE SHALL HAVE A MINIMUM COMPRESSIVE STRENGTH (f'c) OF 3000 psi AT 28 DAYS, UNLESS NOTED OTHERWISE. NO MORE THAN 90 MINUTES SHALL ELAPSE FROM BATCH TIME TO TIME OF PLACEMENT UNLESS APPROVED BY THE ENGINEER OF RECORD. TEMPERATURE OF CONCRETE SHALL NOT EXCEED 90°F AT TIME OF PLACEMENT.
- 4. CONCRETE EXPOSED TO FREEZE—THAW CYCLES SHALL CONTAIN AIR ENTRAINING ADMIXTURES. AMOUNT OF AIR ENTRAINMENT TO BE BASED ON SIZE OF AGGREGATE AND F3 CLASS EXPOSURE (VERY SEVERE). CEMENT USED TO BE TYPE II PORTLAND CEMENT WITH A MAXIMUM WATER—TO—CEMENT RATIO (W/C) OF 0.45.
- 5. ALL STEEL REINFORCING SHALL CONFORM TO ASTM A615. ALL WELDED WIRE FABRIC (WWF) SHALL CONFORM TO ASTM A185. ALL SPLICES SHALL BE CLASS "B" TENSION SPLICES, UNLESS NOTED OTHERWISE. ALL HOOKS SHALL BE STANDARD 90 DEGREE HOOKS, UNLESS NOTED OTHERWISE. YIELD STRENGTH (Fy) OF STANDARD DEFORMED BARS ARE AS FOLLOWS:

#4 BARS AND SMALLER 40 ksi

#5 BARS AND LARGER 60 ksi

- 6. THE FOLLOWING MINIMUM CONCRETE COVER SHALL BE PROVIDED FOR REINFORCING STEEL UNLESS SHOWN OTHERWISE ON DRAWINGS:
- CONCRETE CAST AGAINST AND PERMANENTLY EXPOSED TO EARTH 3"
- CONCRETE EXPOSED TO EARTH OR WEATHER:
- #6 BARS AND LARGER 2"
- #5 BARS AND SMALLER 1-1/2"
- CONCRETE NOT EXPOSED TO EARTH OR WEATHER:
- SLAB AND WALLS 3/4"
- BEAMS AND COLUMNS 1-1/2"
- 7. A TOOLED EDGE OR A 3/4" CHAMFER SHALL BE PROVIDED AT ALL EXPOSED EDGES OF CONCRETE, UNLESS NOTED OTHERWISE, IN ACCORDANCE WITH ACI 301 SECTION 4.2.4.

ELECTRICAL INSTALLATION NOTES:

- 1. ALL ELECTRICAL WORK SHALL BE PERFORMED IN ACCORDANCE WITH THE PROJECT SPECIFICATIONS, NEC AND ALL APPLICABLE FEDERAL, STATE, AND LOCAL CODES/ORDINANCES.
- 2. CONDUIT ROUTINGS ARE SCHEMATIC. CONTRACTOR SHALL INSTALL CONDUITS SO THAT ACCESS TO EQUIPMENT IS NOT BLOCKED AND TRIP HAZARDS ARE ELIMINATED.
- 3. WIRING, RACEWAY AND SUPPORT METHODS AND MATERIALS SHALL COMPLY WITH THE REQUIREMENTS OF THE NEC.
- 4. ALL CIRCUITS SHALL BE SEGREGATED AND MAINTAIN MINIMUM CABLE SEPARATION AS REQUIRED BY THE NEC.
- 4.1. ALL EQUIPMENT SHALL BEAR THE UNDERWRITERS LABORATORIES LABEL OF APPROVAL, AND SHALL CONFORM TO REQUIREMENT OF THE NATIONAL ELECTRICAL CODE.
- 4.2. ALL OVERCURRENT DEVICES SHALL HAVE AN INTERRUPTING CURRENT RATING THAT SHALL BE GREATER THAN THE SHORT CIRCUIT CURRENT TO WHICH THEY ARE SUBJECTED, 22,000 AIC MINIMUM. VERIFY AVAILABLE SHORT CIRCUIT CURRENT DOES NOT EXCEED THE RATING OF ELECTRICAL EQUIPMENT IN ACCORDANCE WITH ARTICLE 110.24 NEC OR THE MOST CURRENT ADOPTED CODE PRE THE GOVERNING JURISDICTION.
- 5. EACH END OF EVERY POWER PHASE CONDUCTOR, GROUNDING CONDUCTOR, AND TELCO CONDUCTOR OR CABLE SHALL BE LABELED WITH COLOR—CODED INSULATION OR ELECTRICAL TAPE (3M BRAND, 1/2" PLASTIC ELECTRICAL TAPE WITH UV PROTECTION, OR EQUAL). THE IDENTIFICATION METHOD SHALL CONFORM WITH NEC AND OSHA.
- 6. ALL ELECTRICAL COMPONENTS SHALL BE CLEARLY LABELED WITH LAMICOID TAGS SHOWING THEIR RATED VOLTAGE, PHASE CONFIGURATION, WIRE CONFIGURATION, POWER OR AMPACITY RATING AND BRANCH CIRCUIT ID NUMBERS (i.e. PANEL BOARD AND CIRCUIT ID'S).
- 7. PANEL BOARDS (ID NUMBERS) SHALL BE CLEARLY LABELED WITH PLASTIC LABELS.
- 8. TIE WRAPS ARE NOT ALLOWED.
- 9. ALL POWER AND EQUIPMENT GROUND WIRING IN TUBING OR CONDUIT SHALL BE SINGLE COPPER CONDUCTOR (#14 OR LARGER) WITH TYPE THHW, THWN, THWN-2, XHHW, XHHW-2, THW, THW-2, RHW, OR RHW-2 INSULATION UNLESS OTHERWISE SPECIFIED.
- 10. SUPPLEMENTAL EQUIPMENT GROUND WIRING LOCATED INDOORS SHALL BE SINGLE COPPER CONDUCTOR (#6 OR LARGER) WITH TYPE THHW, THWN, THWN-2, XHHW, XHHW-2, THW, THW-2, RHW, OR RHW-2 INSULATION UNLESS OTHERWISE SPECIFIED.
- 11. POWER AND CONTROL WIRING IN FLEXIBLE CORD SHALL BE MULTI-CONDUCTOR, TYPE SOOW CORD (#14 OR LARGER) UNLESS OTHERWISE SPECIFIED.
- 12. POWER AND CONTROL WIRING FOR USE IN CABLE TRAY SHALL BE MULTI-CONDUCTOR, TYPE TC CABLE (#14 OR LARGER), WITH TYPE THHW, THWN, THWN-2, XHHW, XHHW-2, THW, THW-2, RHW, OR RHW-2 INSULATION UNLESS OTHERWISE SPECIFIED.
- 13. ALL POWER AND GROUNDING CONNECTIONS SHALL BE CRIMP—STYLE, COMPRESSION WIRE LUGS AND WIRE NUTS BY THOMAS AND BETTS (OR EQUAL). LUGS AND WIRE NUTS SHALL BE RATED FOR OPERATION NOT LESS THAN 75° C (90° C IF AVAILABLE).
- 14. RACEWAY AND CABLE TRAY SHALL BE LISTED OR LABELED FOR ELECTRICAL USE IN ACCORDANCE WITH NEMA, UL, ANSI/IEEE AND NEC.
- 15. ELECTRICAL METALLIC TUBING (EMT), INTERMEDIATE METAL CONDUIT (IMC), OR RIGID METAL CONDUIT (RMC) SHALL BE USED FOR EXPOSED INDOOR LOCATIONS.

- ELECTRICAL METALLIC TUBING (EMT) OR METAL—CLAD CABLE (MC) SHALL BE USED FOR CONCEALED INDOOR LOCATIONS.
- 17. SCHEDULE 40 PVC UNDERGROUND ON STRAIGHTS AND SCHEDULE 80 PVC FOR ALL ELBOWS/90s AND ALL APPROVED ABOVE GRADE PVC CONDUIT.
- 18. LIQUID-TIGHT FLEXIBLE METALLIC CONDUIT (LIQUID-TITE FLEX) SHALL BE USED INDOORS AND OUTDOORS, WHERE VIBRATION OCCURS OR FLEXIBILITY IS NEEDED.
- 19. CONDUIT AND TUBING FITTINGS SHALL BE THREADED OR COMPRESSION—TYPE AND APPROVED FOR THE LOCATION USED. SET SCREW FITTINGS ARE NOT ACCEPTABLE.
- 20. CABINETS, BOXES AND WIRE WAYS SHALL BE LABELED FOR ELECTRICAL USE IN ACCORDANCE WITH NEMA, UL, ANSI/IEEE AND THE NEC.
- 21. WIREWAYS SHALL BE METAL WITH AN ENAMEL FINISH AND INCLUDE A HINGED COVER, DESIGNED TO SWING OPEN DOWNWARDS (WIREMOLD SPECMATE WIREWAY).
- 2. SLOTTED WIRING DUCT SHALL BE PVC AND INCLUDE COVER (PANDUIT TYPE E OR EQUAL).
- 23. CONDUITS SHALL BE FASTENED SECURELY IN PLACE WITH APPROVED NON-PERFORATED STRAPS AND HANGERS. EXPLOSIVE DEVICES (i.e. POWDER-ACTUATED) FOR ATTACHING HANGERS TO STRUCTURE WILL NOT BE PERMITTED. CLOSELY FOLLOW THE LINES OF THE STRUCTURE, MAINTAIN CLOSE PROXIMITY TO THE STRUCTURE AND KEEP CONDUITS IN TIGHT ENVELOPES. CHANGES IN DIRECTION TO ROUTE AROUND OBSTACLES SHALL BE MADE WITH CONDUIT OUTLET BODIES. CONDUIT SHALL BE INSTALLED IN A NEAT AND WORKMANLIKE MANNER. PARALLEL AND PERPENDICULAR TO STRUCTURE WALL AND CEILING LINES. ALL CONDUIT SHALL BE FISHED TO CLEAR OBSTRUCTIONS. ENDS OF CONDUITS SHALL BE TEMPORARILY CAPPED FLUSH TO FINISH GRADE TO PREVENT CONCRETE, PLASTER OR DIRT FROM ENTERING. CONDUITS SHALL BE RIGIDLY CLAMPED TO BOXES BY GALVANIZED MALLEABLE IRON BUSHING ON INSIDE AND GALVANIZED MALLEABLE IRON LOCKNUT ON OUTSIDE AND INSIDE.
- 24. EQUIPMENT CABINETS, TERMINAL BOXES, JUNCTION BOXES AND PULL BOXES SHALL BE GALVANIZED OR EPOXY—COATED SHEET STEEL. SHALL MEET OR EXCEED UL 50 AND BE RATED NEMA 1 (OR BETTER) FOR INTERIOR LOCATIONS AND NEMA 3 (OR BETTER) FOR EXTERIOR LOCATIONS.
- 25. METAL RECEPTACLE, SWITCH AND DEVICE BOXES SHALL BE GALVANIZED, EPOXY—COATED OR NON—CORRODING; SHALL MEET OR EXCEED UL 514A AND NEMA OS 1 AND BE RATED NEMA 1 (OR BETTER) FOR INTERIOR LOCATIONS AND WEATHER PROTECTED (WP OR BETTER) FOR EXTERIOR LOCATIONS.
- 26. NONMETALLIC RECEPTACLE, SWITCH AND DEVICE BOXES SHALL MEET OR EXCEED NEMA OS 2 (NEWEST REVISION) AND BE RATED NEMA 1 (OR BETTER) FOR INTERIOR LOCATIONS AND WEATHER PROTECTED (WP OR BETTER) FOR EXTERIOR LOCATIONS.
- 27. THE CONTRACTOR SHALL NOTIFY AND OBTAIN NECESSARY AUTHORIZATION FROM THE CARRIER AND/OR DISH Wireless L.L.C. AND TOWER OWNER BEFORE COMMENCING WORK ON THE AC POWER DISTRIBUTION PANELS.
- 28. THE CONTRACTOR SHALL PROVIDE NECESSARY TAGGING ON THE BREAKERS, CABLES AND DISTRIBUTION PANELS IN ACCORDANCE WITH THE APPLICABLE CODES AND STANDARDS TO SAFEGUARD LIFE AND PROPERTY.
- 29. INSTALL LAMICOID LABEL ON THE METER CENTER TO SHOW "DISH Wireless L.L.C.".
- 30. ALL EMPTY/SPARE CONDUITS THAT ARE INSTALLED ARE TO HAVE A METERED MULE TAPE PULL CORD INSTALLED.

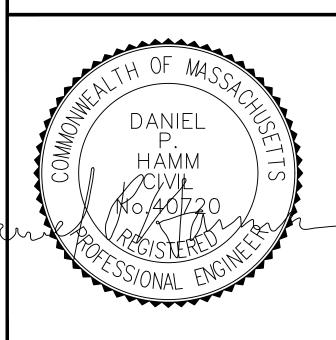


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RFDS REV #:

PRELIMINARY DOCUMENTS

SUBMITTALS

REV DATE DESCRIPTION

A 11/15/2021 ISSUED FOR REVIEW

B 01/21/2022 ISSUED FOR REVIEW

A&E PROJECT NUMBER

BOBOS00592A

DISH Wireless L.L.C.

PROJECT INFORMATION
BOBOS00592A
CROWN CASTLE BU#841273
344 ROUTE 6
NORTH TRURO, MA 02652

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GENERAL NOTES

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GROUNDING NOTES:

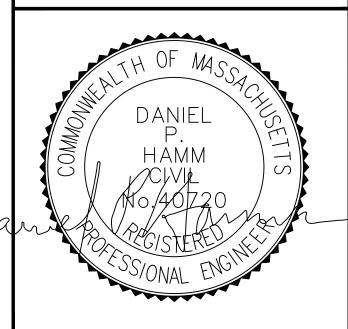
- 1. ALL GROUND ELECTRODE SYSTEMS (INCLUDING TELECOMMUNICATION, RADIO, LIGHTNING PROTECTION AND AC POWER GES'S) SHALL BE BONDED TOGETHER AT OR BELOW GRADE, BY TWO OR MORE COPPER BONDING CONDUCTORS IN ACCORDANCE WITH THE NEC.
- 2. THE CONTRACTOR SHALL PERFORM IEEE FALL-OF-POTENTIAL RESISTANCE TO EARTH TESTING (PER IEEE 1100 AND 81) FOR GROUND ELECTRODE SYSTEMS, THE CONTRACTOR SHALL FURNISH AND INSTALL SUPPLEMENTAL GROUND ELECTRODES AS NEEDED TO ACHIEVE A TEST RESULT OF 5 OHMS OR LESS.
- 3. THE CONTRACTOR IS RESPONSIBLE FOR PROPERLY SEQUENCING GROUNDING AND UNDERGROUND CONDUIT INSTALLATION AS TO PREVENT ANY LOSS OF CONTINUITY IN THE GROUNDING SYSTEM OR DAMAGE TO THE CONDUIT AND PROVIDE TESTING RESULTS.
- 4. METAL CONDUIT AND TRAY SHALL BE GROUNDED AND MADE ELECTRICALLY CONTINUOUS WITH LISTED BONDING FITTINGS OR BY BONDING ACROSS THE DISCONTINUITY WITH #6 COPPER WIRE UL APPROVED GROUNDING TYPE CONDUIT CLAMPS.
- 5. METAL RACEWAY SHALL NOT BE USED AS THE NEC REQUIRED EQUIPMENT GROUND CONDUCTOR. STRANDED COPPER CONDUCTORS WITH GREEN INSULATION, SIZED IN ACCORDANCE WITH THE NEC, SHALL BE FURNISHED AND INSTALLED WITH THE POWER CIRCUITS TO BTS EQUIPMENT.
- 6. EACH CABINET FRAME SHALL BE DIRECTLY CONNECTED TO THE MASTER GROUND BAR WITH GREEN INSULATED SUPPLEMENTAL EQUIPMENT GROUND WIRES, #6 STRANDED COPPER OR LARGER FOR INDOOR BTS; #2 BARE SOLID TINNED COPPER FOR OUTDOOR BTS.
- 7. CONNECTIONS TO THE GROUND BUS SHALL NOT BE DOUBLED UP OR STACKED BACK TO BACK CONNECTIONS ON OPPOSITE SIDE OF THE GROUND BUS ARE PERMITTED.
- 8. ALL EXTERIOR GROUND CONDUCTORS BETWEEN EQUIPMENT/GROUND BARS AND THE GROUND RING SHALL BE #2 SOLID TINNED COPPER UNLESS OTHERWISE INDICATED.
- 9. ALUMINUM CONDUCTOR OR COPPER CLAD STEEL CONDUCTOR SHALL NOT BE USED FOR GROUNDING CONNECTIONS.
- 10. USE OF 90° BENDS IN THE PROTECTION GROUNDING CONDUCTORS SHALL BE AVOIDED WHEN 45° BENDS CAN BE ADEQUATELY SUPPORTED.
- 11. EXOTHERMIC WELDS SHALL BE USED FOR ALL GROUNDING CONNECTIONS BELOW GRADE.
- 12. ALL GROUND CONNECTIONS ABOVE GRADE (INTERIOR AND EXTERIOR) SHALL BE FORMED USING HIGH PRESS CRIMPS.
- 13. COMPRESSION GROUND CONNECTIONS MAY BE REPLACED BY EXOTHERMIC WELD CONNECTIONS.
- 14. ICE BRIDGE BONDING CONDUCTORS SHALL BE EXOTHERMICALLY BONDED OR BOLTED TO THE BRIDGE AND THE TOWER GROUND BAR.
- 15. APPROVED ANTIOXIDANT COATINGS (i.e. CONDUCTIVE GEL OR PASTE) SHALL BE USED ON ALL COMPRESSION AND BOLTED GROUND CONNECTIONS.
- 16. ALL EXTERIOR GROUND CONNECTIONS SHALL BE COATED WITH A CORROSION RESISTANT MATERIAL.
- 17. MISCELLANEOUS ELECTRICAL AND NON-ELECTRICAL METAL BOXES, FRAMES AND SUPPORTS SHALL BE BONDED TO THE GROUND RING, IN ACCORDANCE WITH THE NEC.
- 18. BOND ALL METALLIC OBJECTS WITHIN 6 ft OF MAIN GROUND RING WITH (1) #2 BARE SOLID TINNED COPPER GROUND CONDUCTOR.
- 19. GROUND CONDUCTORS USED FOR THE FACILITY GROUNDING AND LIGHTNING PROTECTION SYSTEMS SHALL NOT BE ROUTED THROUGH METALLIC OBJECTS THAT FORM A RING AROUND THE CONDUCTOR, SUCH AS METALLIC CONDUITS, METAL SUPPORT CLIPS OR SLEEVES THROUGH WALLS OR FLOORS. WHEN IT IS REQUIRED TO BE HOUSED IN CONDUIT TO MEET CODE REQUIREMENTS OR LOCAL CONDUITIONS, NON-METALLIC MATERIAL SUCH AS PVC CONDUIT SHALL BE USED. WHERE USE OF METAL CONDUIT IS UNAVOIDABLE (i.e., NONMETALLIC CONDUIT PROHIBITED BY LOCAL CODE) THE GROUND CONDUCTOR SHALL BE BONDED TO EACH END OF THE METAL CONDUIT
- 20. ALL GROUNDS THAT TRANSITION FROM BELOW GRADE TO ABOVE GRADE MUST BE #2 BARE SOLID TINNED COPPER IN 3/4" NON-METALLIC, FLEXIBLE CONDUIT FROM 24" BELOW GRADE TO WITHIN 3" TO 6" OF CAD-WELD TERMINATION POINT. THE EXPOSED END OF THE CONDUIT MUST BE SEALED WITH SILICONE CAULK. (ADD TRANSITIONING GROUND STANDARD DETAIL AS WELL).
- 21. BUILDINGS WHERE THE MAIN GROUNDING CONDUCTORS ARE REQUIRED TO BE ROUTED TO GRADE, THE CONTRACTOR SHALL ROUTE TWO GROUNDING CONDUCTORS FROM THE ROOFTOP, TOWERS, AND WATER TOWERS GROUNDING RING, TO THE EXISTING GROUNDING SYSTEM, THE GROUNDING CONDUCTORS SHALL NOT BE SMALLER THAN 2/O COPPER. ROOFTOP GROUNDING RING SHALL BE BONDED TO THE EXISTING GROUNDING SYSTEM, THE BUILDING STEEL COLUMNS, LIGHTNING PROTECTION SYSTEM, AND BUILDING MAIN WATER LINE (FERROUS OR NONFERROUS METAL PIPING ONLY). DO NOT ATTACH GROUNDING TO FIRE SPRINKLER SYSTEM PIPES.



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